STATE OF DELAWARE DEPARTMENT OF NATURAL RESOURCES AND ENVIRONMENTAL CONTROL DIVISION OF PARKS AND RECREATION



KILLENS POND STATE PARK ELEVATED WALKWAY

5025 KILLENS POND ROAD, FELTON, DE 19943

AUGUST 2020

PROJECT NO.

KPSP-28



SHEET NO.

SHEET TITLE

CONSTRUCTION PLANS

C100

COVER SHEET

C101

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 WALKWAY PLAN AND ELEVATION

 S602
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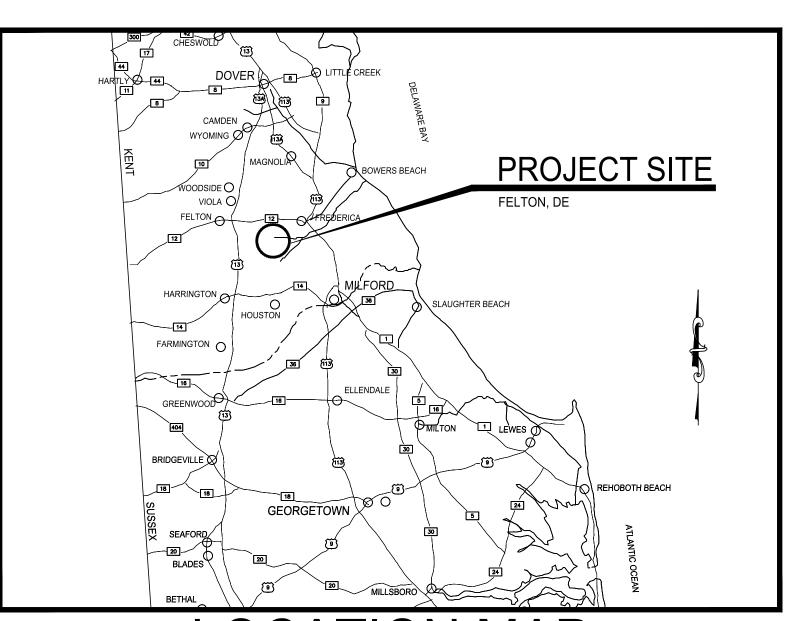
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SSMP500 STORMWATER MANAGEMENT COVER SHEET
SSMP501 EROSION AND SEDIMENT CONTROL PLAN
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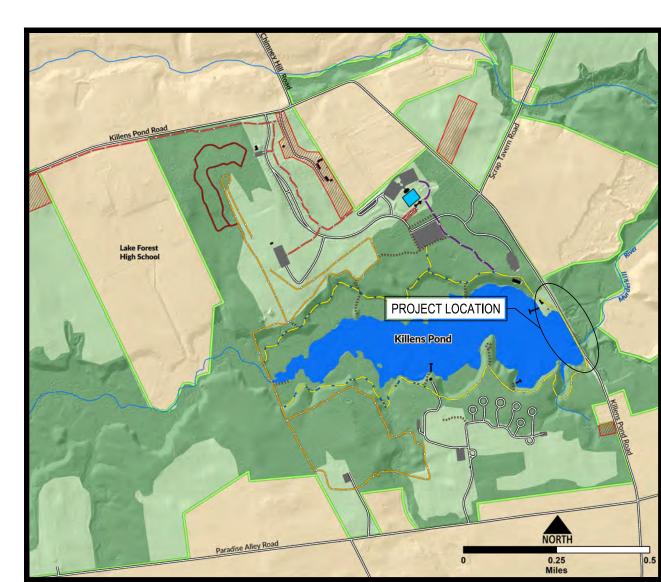
LOCATION MAP

Lake Forest Central ES PONO Park Office Lake Forest HS Softball Fields	19943 Parking ************************************		Coursey Pond POND COURSEY COURSEY	
	LLENS POND STATE PARK Trail Hiking KILLENS PON	PROJECT LOCA	TION (15)	CANTERBURY LAW
derkill (RO 426)	Boating Fishing Swimming Parking	Killens DR STONE DR PARADISE	PARADISE ESTS TO SELECTION OF THE PARADI	i.
(HD 420)	CLAR STORM ROLL OF THE STORM R	1 1 1 1 1 1 1 1 1 1 1 1 1 1 1 1 1 1 1	CARRENTER	


SITE MAP



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PARK MAP




OFFICE OF DESIGN & DEVELOPMENT
DELAWARE DIVISION OF PARKS & RECREATION
89 KINGS HIGHWAY

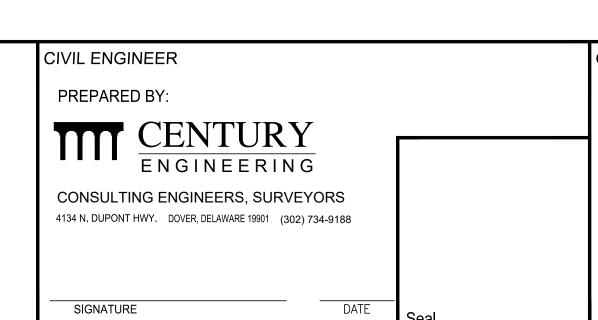DELAWARE DIVISION OF PARKS & RECREATION 89 KINGS HIGHWAY DOVER, DELAWARE 19901 (302) 739-9231 (302) 739-7026 (FAX)

SIGNATURE DATE

POND STATE PARK ATED WALKWAY

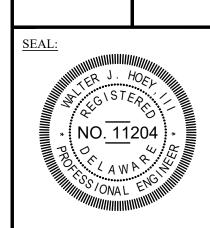

CIVIL ENGINEER:

CENTURY
ENGINEERING
CONSULTING ENGINEERS, SURVEYOR
4134 N. DUPONT HWY.
DOVER, DELAWARE 19901

CEI CONTRACT NO.: 175013.11



DESIGNED BY:

DRAWN BY:

JSW CHECKED BY:

DATE:

AUGUST 2020
SCALE:

NONE SHEET NO.:

C100

CONTRACT NO.: 2020-KP-100

PROJECT NOTES:

- THE INTENT OF THIS PROJECT IS TO PROVIDE THE FOLLOWING IMPROVEMENTS AT KILLENS POND STATE PARK 1.1. CONSTRUCTION OF A NEW PRE-MANUFACTURED ALUMINUM ELEVATED WALKWAY OVER KILLENS POND, PARALLEL WITH KILLENS POND ROAD. WALKWAY WILL CONNECT THE EXISTING BOAT RAMP AREA TO THE CANOE LAUNCH AREA. AND OVERALL LENGTH TO BE 868±
- LINEAR FEET (0.164 MILES). INSTALLATION OF GALVANIZED STEEL PIPE PILE PIER BENTS WITHIN KILLENS POND.
- CONSTRUCTION OF REINFORCED CONCRETE ABUTMENTS LOCATED AT THE NORTH AND SOUTH ENDS OF THE WALKWAY. CONSTRUCTION OF A GRAVEL TRAIL LEADING FROM THE NORTH END OF THE ELEVATED WALKWAY TO THE EXISTING NATURE CENTER TRAIL,
- AS SHOWN ON THESE PLANS. REPAVING THE EXISTING BOAT RAMP PARKING LOT AT THE SOUTH END OF THE PROJECT AT THE END OF THE CONSTRUCTION.
- MISCELLANEOUS CONSTRUCTION AND SITE WORK, AS SHOWN ON THESE PLANS.
- THESE PLANS HAVE BEEN DEVELOPED IN ACCORDANCE WITH THE FOLLOWING: 2.1. UNITED STATES ACCESS BOARD "ACCESSIBILITY STANDARDS FOR FEDERAL OUTDOOR DEVELOPED AREAS".
- 2.2. AASHTO "GUIDE FOR THE DEVELOPMENT OF BICYCLE FACILITIES". 2.3. AASHTO "LRFD GUIDE SPECIFICATIONS FOR THE DESIGN OF PEDESTRIAN BRIDGES"
- APPROVED SHOP DRAWINGS FOR THE PRE-MANUFACTURED ALUMINUM WALKWAY ARE INCLUDED WITH THIS PLAN PACKAGE.
- AT THE TIME OF DELIVERY, THE CONTRACTOR SHALL BE RESPONSIBLE FOR INSPECTING, RECEIVING, TAKING OWNERSHIP, OFF-LOADING, AND STORAGE OF THE PRE-MANUFACTURED ALUMINUM WALKWAY. WALKWAY PANELS SHALL BE STORED ON NATURAL TIMBER CRIBBING WITH NATURAL TIMBER DUNNAGE. NO TREATED WOOD SHALL BE USED FOR MATTING OR DUNNAGE. THE ENTIRE ELEVATED WALKWAY SHALL BE DELIVERED AT ONE TIME. OR WITHIN A REASONABLY CLOSE TIME-FRAME. STORAGE SHALL BE IN THE PARKING LOT BEHIND THE WATER PARK. THIS WORK SHALL BE INCLUDED IN THE PRICE BID FOR THIS PROJECT AND SHALL INCLUDE RELOCATING THE MATERIAL FROM THE STORAGE
- THE CONTRACTOR SHALL BE RESPONSIBLE FOR PROVIDING ALL ANCHOR BOLTS USED TO SECURE THE PRE-MANUFACTURED ALUMINUM WALKWAY TO THE ABUTMENTS AND PIER CAPS.
- . STEEL PILES AND PIER CAPS SHALL BE THE RESPONSIBILITY OF THE CONTRACTOR.
- CONSTRUCTION OF THE ELEVATED WALKWAY SHALL BEGIN AT OR NEAR THE MID-POINT OF THE STRUCTURE AND PROGRESS NORTH AND SOUTH TO PREVENT UNAUTHORIZED PEDESTRIAN ACCESS DURING CONSTRUCTION.
- NO CONSTRUCTION SHALL TAKE PLACE WITHIN THE WATERS OF KILLENS POND BETWEEN APRIL 1 AND JULY 15, 2020, IN ACCORDANCE WITH DNREC FISH AND WILDLIFE RESTRICTIONS.
- PARCEL AND BOUNDARY LINES TAKEN FROM GIS INFORMATION. NO BOUNDARY SURVEY WAS REQUESTED OR PERFORMED FOR THIS PROJECT.
- THESE PLANS WERE DEVELOPED FROM AERIAL SURVEY PROVIDED BY DNREC PARKS. CONVENTIONAL FIELD SURVEY WAS PROVIDED FOR THE AREA OF THE BRIDGE CROSSING AND THE NORTHERN HALF OF THE TRAIL BY CENTURY ENGINEERING. CONTROL POINTS FOR THE CONVENTIONAL SURVEY HAVE BEEN INCLUDED IN THESE PLANS. THE CONTRACTOR IS RESPONSIBLE FOR PROVIDING ALL ADDITIONAL PHYSICAL CONTROL AND LAYOUT, INCLUDING BUT NOT LIMITED TO BASELINE(S) AND WORKING POINTS, AS REQUIRED TO COMPLETE THE WORK AT NO ADDITIONAL COST TO THE OWNER.
- EXISTING UTILITIES SHOWN ARE BASED ON THE BEST INFORMATION AVAILABLE AT THE TIME THIS PLAN WAS DEVELOPED. COMPLETENESS OR CORRECTNESS OF THE UTILITIES SHOWN THEREOF IS NOT GUARANTEED. THE CONTRACTOR IS RESPONSIBLE FOR CONTACTING MISS UTILITY OF DELAWARE AND FOR EMPLOYING AN UNDERGROUND UTILITY LOCATOR TO LOCATE AND MARK EXISTING UTILITIES WITHIN THE LIMIT OF DISTURBANCE PRIOR TO BEGINNING CONSTRUCTION.
- THE CONTRACTOR SHALL BE RESPONSIBLE FOR TEMPORARY RELOCATION OR SUPPORT OF ANY ELECTRICAL AND COMMUNICATION LINES, AND ELECTRICAL/COMMUNICATION PEDESTALS THAT INTERFERE WITH THE PROPOSED WORK AT NO ADDITIONAL COST TO THE PROJECT. AS DIRECTED BY THE ENGINEER. WORK SHALL INCLUDE, BUT IS NOT LIMITED TO, EXCAVATION/TRENCHING, MATERIALS, AND ALL LABOR.
- WORK, INCLUDING STAGING, SHALL BE CONFINED TO THE LIMIT OF DISTURBANCE SHOWN ON THE PLANS. ADDITIONAL, MATERIAL STORAGE AREAS NECESSARY FOR THE PREMANUFACTURED ALUMINUM WALKWAY PANELS, AND OTHER OVERSIZED ITEMS, SHALL BE ON A PAVED SURFACE WITHIN THE PARK AT A REMOTE LOCATION TO BE DETERMINED BY THE OWNER. THE CONTRACTOR SHALL ACCOUNT FOR THE MANHOURS, EQUIPMENT, AND TRANSPORTATION COSTS TO MOVE/RELOCATE ITEMS FROM THE REMOTE STORAGE AREA TO THE CONSTRUCTION SITE IN HIS/HER BID PRICE
- PORTIONS OF THIS CONTRACT ARE TO BE CONSTRUCTED IN ACCORDANCE WITH DELAWARE DEPARTMENT OF TRANSPORTATION STANDARD SPECIFICATIONS FOR ROAD AND BRIDGE CONSTRUCTION (STANDARD SPECIFICATIONS) DATED AUGUST 2016 INCLUDING ALL REVISIONS UP TO ADVERTISEMENT OF THIS PROJECT, UNLESS NOTED OTHERWISE IN THESE PLANS OR THE SPECIFICATIONS. ITEMS INCLUDING, BUT NOT LIMITED TO, EXCAVATION AND EMBANKMENT, ARE TO REFER TO THE "STANDARD SPECIFICATIONS" FOR MATERIALS AND METHOD OF CONSTRUCTION.
- TOPSOIL SHALL BE STRIPPED, STOCKPILED, AND STABILIZED FOR FUTURE USE IN ACCORDANCE WITH THE DELAWARE EROSION & SEDIMENT CONTROL HANDBOOK, CURRENT EDITION. STOCKPILE AREAS TO BE WITHIN KILLENS POND STATE PARK AT LOCATIONS SHOWN ON THESE PLANS, OR AT AREAS DETERMINED BY THE ENGINEER IN THE FIELD.
- EXCAVATED SOILS THAT ARE SUITABLE FOR FILL WITHIN THIS PROJECT SHALL BE STOCKPILED AND STABILIZED FOR FUTURE USE IN ACCORDANCE WITH THE DELAWARE EROSION & SEDIMENT CONTROL HANDBOOK, CURRENT EDITION. STOCKPILE(S) TO BE WITHIN KILLENS POND STATE PARK AT LOCATIONS SHOWN ON THESE PLANS.
- EXCESS EXCAVATED MATERIAL SHALL BECOME THE PROPERTY OF THE CONTRACTOR AND SHALL BE LEGALLY DISPOSED OF OFF SITE.

 APPROXIMATELY 64 CUBIC YARDS OF EXCESS MATERIAL IS ANTICIPATED TO BE GENERATED FROM THIS CONSTRUCTION.
- 8. CLEARING AND GRUBBING IS ASSUMED TO EXTEND A MINIMUM OF EIGHTEEN (18) INCHES BELOW EXISTING GRADE. CLEARING AND GRUBBING WITHIN THE LIMITS OF DISTURBANCE (LOD) SHALL CONSIST OF CLEARING, GRUBBING, REMOVING AND DISPOSING OF ALL TREES, ROOTS, VEGETATION AND DEBRIS OFF SITE, UNLESS OTHERWISE INDICATED AND/OR EXCEPT SUCH OBJECT(S) THAT ARE DESIGNATED TO REMAIN.
- ALL TREE REMOVAL AND TREE TRIMMING WITHIN THE LIMITS OF DISTURBANCE, REGARDLESS OF SIZE, SHALL BE INCIDENTAL TO THE CONTRACT INDIVIDUAL TREES ARE NOT SHOWN ON THE DRAWINGS BUT MAY BE REMOVED BY THE CONTRACTOR AS NECESSARY WITHIN THE LIMITS OF DISTURBANCE. TREES GREATER THAN 6" IN DIAMETER SHALL BE FLAGGED BY THE CONTRACTOR FOR REVIEW AND APPROVAL BY THE FNGINEER PRIOR TO REMOVAL. THE CONTRACTOR SHALL NOT REMOVE TREES WITHOUT PRIOR APPROVAL OF THE OWNER.
- 20. TREES NOT DESIGNATED TO BE REMOVED SHALL BE PROTECTED FROM CONSTRUCTION EQUIPMENT AND COMPACTION OF SOIL WITHIN THE DRIP LINE BY MEANS OF 3'-0" HIGH SENSITIVE AREA PROTECTION (SAP) FENCE, AS SHOWN ON THE EROSION AND SEDIMENT CONTROL PLANS.
- 21. CROSS SLOPE OF ALL NEW WALKWAYS SHALL NOT EXCEED A SLOPE OF 1:50. LONGITUDINAL SLOPES OF ALL NEW WALKWAYS SHALL NOT EXCEED 1:20, UNLESS SHOWN OTHERWISE ON THE CONTRACT PLANS.
- 22. THE CONTRACTOR MAY STORE AND/OR STOCKPILE EQUIPMENT AND MATERIALS WITHIN THE PROJECT SITE LIMIT OF CONSTRUCTION (LOC) SHOWN ON PLAN. REFER TO THE SEDIMENT AND EROSION CONTROL PLANS FOR ADDITIONAL INFORMATION.
- 23. THE CONTRACTOR IS ADVISED THAT CONTRACTOR EMPLOYEE PARKING SHALL BE LIMITED TO THE EXISTING PAVED PARK PARKING AREAS.
- UNLESS APPROVED BY THE ENGINEER. VEHICLE PARKING SHALL NOT BE ALLOWED ON UNPAVED AREAS OR ALONG KILLENS POND ROAD.
- 24. FEATURES NOT SPECIFICALLY DESIGNATED FOR DEMOLITION OR REMOVAL THAT ARE DAMAGED BY THE CONTRACTOR OR THE CONTRACTOR'S SUBCONTRACTORS SHALL BE REPAIRED OR REPLACED BY THE CONTRACTOR AT NO ADDITIONAL COST TO THE STATE. THE COST FOR REPAIRS OR REPLACEMENT SHALL BE ESTABLISHED BY THE STATE INSURANCE PROVIDER.
- 25. THE CONTRACTOR SHALL PREVENT DEBRIS, TOOLS, AND CONSTRUCTION MATERIAL FROM FALLING IN THE WATER.
- 26. REMOVAL OF VEGETATION WITHIN WETLANDS SHALL CONSIST OF CUTTING DOWN TO WITHIN SIX (6) INCHES OF EXISTING GRADE. NO GRUBBING SHALL BE ALLOWED.
- THE CONTRACTOR SHALL NOTIFY THE OWNER A MINIMUM OF 48 HOURS PRIOR TO PERFORMING ANY CONSTRUCTION AND/OR TESTING, INCLUDING BUT NOT LIMITED TO POURING CONCRETE.
- 28. ALL TESTING OF MATERIALS SHALL BE PERFORMED AND CERTIFIED BY AN INDEPENDENT THIRD PARTY TESTING AGENCY QUALIFIED FOR EACH
- REQUIRED TEST. 29. TEST PILES SHALL BE TESTED AND CERTIFIED DURING INSTALLATION BY AN INDEPENDENT THIRD PARTY TESTING AGENCY WITH AT LEAST
- 5-YEARS OF EXPERIENCE WITH SIMILAR CONSTRUCTION. TESTING SHALL INCLUDE PILE DRIVING ANALYZER (PDA) TESTING TO DETERMINE PILE DEPTHS AND PILE LENGTHS TO ACHIEVE THE AXIAL LOADING REQUIREMENTS AS SPECIFIED IN THE CONTRACT PLANS.

TRAFFIC CONTROL NOTES:

DISTRICT SAFETY OFFICER.

THE DELAWARE MUTCD.

- 1. THE CONTRACTOR SHALL BE RESPONSIBLE FOR OBTAINING A TRAFFIC SAFETY PERMIT FOR THE TWO TEMPORARY CONSTRUCTION ENTRANCES WITH THE DELAWARE DEPARTMENT OF TRANSPORTATION
- 2. ALL WORK SHALL BE PERFORMED IN A MANNER THAT WILL REASONABLY PROVIDE THE LEAST PRACTICABLE OBSTRUCTION TO ROAD USERS INCLUDING VEHICULAR TRAFFIC, BICYCLE TRAFFIC AND PEDESTRIAN TRAFFIC. NO WORK, STORAGE OF MATERIALS, OR PARKING OF VEHICLES SHALL BE ALLOWED WITHIN TEN (10) FEET OF THE EDGE OF THE ROADWAY.
- NO WORK SHALL BE PERFORMED FROM KILLENS POND ROAD. NO CONSTRUCTION OR PERSONAL VEHICLES SHALL BE PARKED ON OR ALONG KILLENS POND ROAD.
- 4. TYPICAL APPLICATIONS PER THE DELAWARE MUTCD SHALL BE INCORPORATED TO ACHIEVE REQUIRED TEMPORARY TRAFFIC CONTROL AND SAFETY REQUIREMENTS. THIS PROJECT IS SUBJECT TO THE FOLLOWING TYPICAL APPLICATIONS, AS NOTED ABOVE, UNLESS DIRECTED OTHERWISE BY THE DELDOT DISTRICT SAFETY OFFICER:
- 4.1. TYPICAL APPLICATION 6 SHOULDER WORK WITH MINOR ENCROACHMENT ON A TWO-LANE, LOW-SPEED ROAD (≤40 MPH): "WORK WITHIN THE RIGHT OF WAY SHOULDER OF HOPKINS ROAD (TA-6)". TYPICAL APPLICATION 10 - LANE CLOSURE ON A TWO-LANE ROAD USING FLAGGERS: "WORK WITHIN THE TRAVEL LANE OF HOPKINS
- 4.3. TYPE III BARRICADES SHALL BE USED TO BLOCK ENTRANCE TO ALL CONSTRUCTION ALONG KILLENS POND ROAD.

DISTRICT SAFETY OFFICER A MINIMUM OF TWO WEEKS IN ADVANCE OF THE PROPOSED RESTRICTION.

- ANY TEMPORARY TRAFFIC CONTROL AND TEMPORARY TRAFFIC CONTROL DEVICES DEEMED NECESSARY BY THE CONTRACTOR AND AS REQUIRED BY DELDOT, SHALL BE IN ACCORDANCE WITH:
- 5.1. THE CONTRACT DOCUMENTS, THE LATEST EDITION OF THE MANUAL TITLED "STATE OF DELAWARE MANUAL ON UNIFORM TRAFFIC CONTROL DEVICES (MUTCD)" (HEREINAFTER REFERRED TO AS THE "DELAWARE MUTCD"). 5.2. CURRENT STATE OF DELAWARE DEPARTMENT OF TRANSPORTATION STANDARD SPECIFICATIONS FOR ROAD AND BRIDGE CONSTRUCTION,
- AND SUPPLEMENTAL SPECIFICATIONS, INCLUDING ALL REVISIONS AS OF THE DATE OF THE ENTRANCE PERMIT APPROVAL. 6. THE DEPARTMENT RESERVES THE RIGHT TO STOP THE CONTRACTOR'S OPERATIONS, IF, IN THE OPINION OF THE DEPARTMENT'S
- REPRESENTATIVE, THE CONTRACTOR'S OPERATIONS ARE NOT IN COMPLIANCE WITH THE DELAWARE MUTCD, THE SPECIFICATIONS OR THE PLANS OR IF THE CONTRACTOR'S OPERATIONS ARE DEEMED UNSAFE. 7. IF THE CONTRACTOR REQUIRES WORK OR OTHER ACTIVITY WITHIN TEN (10) FEET OF THE STATE ROAD, THE CONTRACTOR SHALL SUBMIT A TEMPORARY TRAFFIC CONTROL PLAN (TTCP) TO THE DELDOT DISTRICT SAFETY OFFICER FOR APPROVAL PRIOR TO THE START OF WORK AT
- SUBMITTED 14 CALENDAR DAYS IN ADVANCE OF STARTING WORK. 8. ALL ROADWAY CLOSURES OR LANE CLOSURES BEYOND THOSE SPECIFIED AND APPROVED IN THE PLANS SHALL BE APPROVED BY THE

EACH AND EVERY LOCATION. THE TTCP SHALL BE PREPARED, SIGNED AND SEALED BY A PROFESSIONAL ENGINEER REGISTERED IN THE

STATE OF DELAWARE AND SHALL BE PREPARED IN ACCORDANCE WITH ALL APPLICABLE DELDOT STANDARDS. THE TTCP SHALL BE

- TEMPORARY TRAFFIC CONTROL DEVICES SHALL BE MAINTAINED IN GOOD CONDITION IN ACCORDANCE WITH THE BROCHURE ENTITLED "QUALITY GUIDELINES FOR TEMPORARY TRAFFIC CONTROL DEVICES", PUBLISHED BY THE AMERICAN TRAFFIC SAFETY SERVICES ASSOCIATION (ATSSA). ANY TEMPORARY TRAFFIC CONTROL DEVICES THAT DO NOT MEET THE QUALITY GUIDELINES SHALL BE REMOVED AND REPLACED WITH ACCEPTABLE DEVICES. FAILURE TO COMPLY WILL RESULT IN WORK STOPPAGE.
- . TEMPORARY TRAFFIC CONTROL DEVICES USED ON ALL ROADWAYS OPEN TO THE PUBLIC IN DELAWARE SHALL CONFORM TO THE DELAWARE MUTCD AND SHALL BE IN NEW OR REFURBISHED CONDITION. ALL DEVICES SHALL BE CRASHWORTHY IN ACCORDANCE WITH THE NATIONAL COOPERATIVE HIGHWAY RESEARCH PROGRAM (NCHRP) REPORT 350 AND/OR IN ACCORDANCE WITH THE LATEST EDITION OF THE MANUAL FOR ASSESSING SAFETY HARDWARE (MASH), PUBLISHED BY THE AMERICAN ASSOCIATION OF STATE HIGHWAY AND TRANSPORTATION OFFICIALS (AASHTO). THE CONTRACTOR SHALL SUBMIT CERTIFICATION FOR ALL TEMPORARY TRAFFIC CONTROL DEVICES USED SPECIFICALLY ON THIS PROJECT TO THE DISTRICT SAFETY OFFICER AT OR PRIOR TO THE PRE-CONSTRUCTION MEETING. THE CONTRACTOR SHALL NOT BEGIN WORK OR PLACE ANY TEMPORARY TRAFFIC CONTROL DEVICES UNTIL THE CERTIFICATION OF DEVICES HAS BEEN APPROVED BY THE
- I. ANY DEFICIENCIES RELATED TO TEMPORARY TRAFFIC CONTROL THAT ARE REPORTED TO THE CONTRACTOR IN WRITING SHALL BE CORRECTED WITHIN 24 HOURS OR AS DIRECTED BY THE DISTRICT SAFETY OFFICER. CORRECTIVE ACTIONS ON SEVERE DEFICIENCIES SHALL BE TAKEN IMMEDIATELY. FAILURE TO COMPLY WILL RESULT IN THE SUSPENSION OF WORK UNTIL DEVICES ARE BROUGHT BACK INTO COMPLIANCE
- 12. ACCESS TO ALL TRANSIT STOPS LOCATED WITHIN THE PROJECT LIMITS SHALL BE MAINTAINED UNLESS OTHERWISE DIRECTED BY THE PLANS OR THE ENGINEER. MAINTAINING ACCESS TO THE TRANSIT STOP SHALL INCLUDE MAINTAINING AN AREA OF THE TRANSIT VEHICLE TO STOP TO PICK-UP AND DISCHARGE PASSENGERS AND ALSO AN ACCESSIBLE PATH FOR PEDESTRIANS TO SAFELY ACCESS THE TRANSIT STOP.
- 13. THE CONTRACTOR SHALL BE RESPONSIBLE FOR NOTIFYING THE LOCAL 911 CENTER, LOCAL SCHOOLS AND THE DELDOT PUBLIC
- 14. THE CONTRACTOR SHALL NOTIFY THE LOCAL 911 CENTER IF ACCESS TO A FIRE HYDRANT IS TEMPORARILY RESTRICTED.
- 15. THE CONTRACTOR SHALL BE RESPONSIBLE FOR ENSURING THAT THE TRANSPORTATION MANAGEMENT CENTER IS NOTIFIED EACH AND EVERY DAY WHEN WORK IS BEING PERFORMED IN STATE RIGHT-OF-WAY. THE CONTRACTOR SHALL IDENTIFY THE TYPE OF WORK, ANY LANE(S)

INFORMATION CENTER OF ALL ROADS AND LANES TO BE CLOSED A MINIMUM OF SEVEN CALENDAR DAYS BEFORE THE CLOSURE.

- OR SHOULDERS CLOSED, THE LENGTH OF TIME FOR WORK, WHEN THE LANE RESTRICTIONS ARE IN PLACE AND WHEN LANE RESTRICTIONS ARE LIFTED, CONTACT PERSON/PHONE NUMBER AND STATE INSPECTOR. THE TRANSPORTATION MANAGEMENT CENTER CAN 16. BE REACHED AT (302) 659-4600.
- 17. AT THE END OF EACH WORKDAY, THE CONTRACTOR SHALL CORRECT ALL VERTICAL DIFFERENCES IN ACCORDANCE WITH TABLE 6G-1 OF THE DELAWARE MUTCD. IF REQUIRED TO MAINTAIN TRAFFIC.
- 18. AT THE END OF EACH DAY'S OPERATION AND BEFORE TRAFFIC IS RETURNED TO UNRESTRICTED ROADWAY USE, TEMPORARY PAVEMENT MARKINGS SHALL BE APPLIED IN ACCORDANCE WITH THE DELAWARE MUTCD AND DELDOT'S TEMPORARY PAVEMENT MARKINGS POLICY.
- 19. WHEN SIDE ROADS INTERSECT THE WORK ZONE, ADDITIONAL TRAFFIC CONTROL DEVICES SHALL BE ERECTED INCLUDING PERMANENT WARNING SIGNS.
- 20. ALL STORAGE OF EQUIPMENT AND MATERIAL SHALL COMPLY WITH SECTION 6G.21 OF THE DELAWARE MUTCD.
- 21. ALL FLAGGERS SHALL COMPLY WITH CHAPTER 6E OF THE DELAWARE MUTCD.
- 22. THE CONTRACTOR SHALL BE RESPONSIBLE FOR COORDINATING HIS/HER WORK WITH OTHER CONTRACTORS IN THE AREA.
- 23. ALL PERSONS WORKING WITHIN THE STATE RIGHT-OF-WAY SHALL WEAR A MINIMUM OF AN ANSI CLASS II SAFETY VEST MEETING OR EXCEEDING THE ANSI 107-2004 REQUIREMENTS, AS SPECIFIED IN THE DELAWARE MUTCD.
- 24. ALL PAVEMENT MARKINGS THAT ARE NO LONGER IN USE AND CONFLICT WITH TEMPORARY PAVEMENT MARKINGS SHALL BE REMOVED AND COMPLETELY OBLITERATED BY A METHOD APPROVED BY THE ENGINEER. PAINTING OVER THE CONFLICTING PAVEMENT MARKINGS WILL NOT
- BE ACCEPTED AS A METHOD OF REMOVAL. 25. THE CONTRACTOR IS RESPONSIBLE FOR THE MAINTENANCE OF EXISTING PAVEMENT WITHIN THE PROJECT LIMITS FOR THE DURATION OF
- THE CONTRACT OR AS DIRECTED BY THE ENGINEER.

26. ALL ROADWAYS AND ENTRANCES NOT OPEN TO TRAFFIC SHALL BE CLOSED USING TYPE III BARRICADES AND SHALL BE INSTALLED PER

EXPERIENCE REQUIREMENTS:

- 1. PROVIDE THE FOLLOWING DOCUMENTATION WITH THE BID SUBMITTAL PACKAGE: 1.1. STEEL PILES SHALL BE INSTALLED BY A CONTRACTOR EXPERIENCED IN PILE DRIVING OPERATIONS IN A MARINE ENVIRONMENT. PROVIDE DOCUMENTATION, INCLUDING JOB NAME(S), LOCATION(S), OWNER(S), AND OWNER(S) CONTACT INFORMATION FOR SIMILAR WORK EXPERIENCE PERFORMED WITHIN THE LAST THREE (3) YEARS.
- 1.2. PREMANUFACTURED BRIDGE SHALL BE INSTALLED BY A CONTRACTOR EXPERIENCED IN THIS TYPE OF WORK. PROVIDE DOCUMENTATION, INCLUDING JOB NAME(S), LOCATION(S), OWNER(S), AND OWNER(S) CONTACT INFORMATION FOR SIMILAR WORK EXPERIENCE PERFORMED WITHIN THE LAST THREE (3) YEARS.

ADA	AMERICANS WITH DISABILITIES ACT	OHW	ORDINARY HIGH WATER
ALUM	ALUMINUM	PL PL	PLATE
BL	BASE LINE	P.L.	PROPERTY LINE
Œ.	CENTER LINE	PSI	POUNDS PER SQUARE INCH
CLR	CLEAR	PT	PRESSURE TREATED
CONC	CONCRETE	REBAR	REINFORCING BAR
E.F.	EACH FACE	ROW	RIGHT OF WAY
EL	ELEVATION	RW	RIGHT OF WAY
ELEV	ELEVATION	SF	SILT FENCE
F.F.	FAR FACE	SS	STAINLESS STEEL
f'c	COMPRESSIVE STRENGH OF CONCRETE	STA	STATION
GALV	GALVANIZED	STL	STEEL
HORIZ	HORIZONTAL	STR	STRAIGHT
LOC	LIMIT OF CONSTRUCTION	T&B	TOP AND BOTTOM
LOD	LIMIT OF DISTURBANCE	TYP	TYPICAL
LRFD	LOAD RESISTANCE FACTORED DESIGN	UHMW	ULTRA HIGH MOLECULAR WEIGHT
MHW	MEAN HIGH WATER	UNO	UNLESS OTHERWISE NOTED
N.F.	NEAR FACE	VERT	VERTICAL

WATER SURFACE ELEVATION

GENERAL NOTES: 1. THE TERM "ENGINEER," "STATE," AND/OR "ARCHITECT" NOTED THROUGHOUT THE CONTRACT PLANS AND SPECIFICATIONS SHALL

REFER TO DNREC / STATE PARKS, OR THEIR APPOINTED REPRESENTATIVE. THE TERM "SITE" AND "PARK" MAY BE USED

THE CONTRACTOR SHALL RESTORE ALL AREAS AFFECTED BY THE CONSTRUCTION SHOWN HEREON AS SHOWN ON THESE PLANS AND SPECIFICATIONS, TO A CONDITION COMPARABLE TO THAT EXISTING PRIOR TO CONSTRUCTION, AND TO THE SATISFACTION OF

INTERCHANGEABLY THROUGHOUT THESE DOCUMENTS AS A MEANS OF IDENTIFYING KILLENS POND STATE PARK.

TRAILER DURING CONSTRUCTION. PARK FACILITIES SHALL NOT BE USED.

DIRECTED BY THE ENGINEER.

- 3. THE CONTRACTOR SHALL PROVIDE NECESSARY FACILITIES, INCLUDING BUT NOT LIMITED TO RESTROOMS, AND CONSTRUCTION
- 4. THE CONTRACTOR SHALL NOTE THAT IN CASE OF DISCREPANCY BETWEEN THE SCALED AND THE FIGURED DIMENSIONS SHOWN ON THE PLANS, THE FIGURED DIMENSIONS SHALL GOVERN. THE CONTRACTOR SHALL BE RESPONSIBLE FOR CONFIRMING ALL DIMENSIONS. THE CONTRACTOR SHALL BE RESPONSIBLE FOR BRINGING ANY DIMENSIONAL DISCREPANCIES TO THE ATTENTION OF THE ENGINEER FOR CLARIFICATION
- THE CONTRACTOR SHALL CONTACT MISS UTILITY TWO (2) CONSECUTIVE WORKING DAYS PRIOR TO EXCAVATION, OR AS REQUIRED BY LAW, AT 1-800-282-8555.
- BEFORE EXCAVATION IS STARTED, THE CONTRACTOR SHALL VERIFY THE LOCATION OF ALL UNDERGROUND UTILITIES. ALL EXISTING UTILITIES SHALL BE PROTECTED AND TEMPORARILY SUPPORTED OR RELOCATED AS NECESSARY TO COMPLETE THE WORK IN ACCORDANCE WITH THE PERTINENT OWNER/UTILITY COMPANY REQUIREMENTS. ANY UTILITIES DAMAGED BY THE CONTRACTOR SHALL BE PROMPTLY AND FULLY RESTORED TO THE SATISFACTION OF THE OWNER.
- THE CONTRACTOR SHALL DESIGNATE A PERSON WHO SHALL BE RESPONSIBLE FOR IMPLEMENTING AND MAINTAINING THE EROSION AND SEDIMENT CONTROL PLANS, A PERSON WHO SHALL BE RESPONSIBLE FOR IMPLEMENTING AND MAINTAINING THE TRAFFIC CONTROL, AND A PERSON WHO SHALL BE RESPONSIBLE FOR WORKER SAFETY. THE PERSON RESPONSIBLE FOR IMPLEMENTING AND MAINTAINING THE EROSION AND SEDIMENT CONTROL PLANS SHALL BE CERTIFIED BY DNREC FOR EROSION AND SEDIMENT CONTROL RESPONSIBILITY (CERTIFIED CONSTRUCTION REVIEWER).
- 8. THE CONTRACTOR IS RESPONSIBLE FOR SECURING THE AREA WITHIN THE LIMITS OF CONSTRUCTION TO PROHIBIT PUBLIC ACCESS AND DIRECT PEDESTRIAN TRAFFIC UNTIL COMPLETION OF THE PROJECT. THE CONTRACTOR'S PROCEDURE/METHOD FOR LIMITING ACCESS SHALL INCLUDE TEMPORARY SAFETY FENCE, AND SHALL BE COORDINATED WITH THE OWNER AND SUBMITTED FOR REVIEWED AND APPROVAL PRIOR TO THE START OF WORK. THE COST TO INSTALL, RELOCATE, AND MAINTAIN SITE SECURITY SHALL BE INCIDENTAL TO THE CONTRACT.
- 9. THE CONTRACTOR IS SOLELY RESPONSIBLE FOR OBTAINING OFF-SITE SPOIL AREAS FOR LEGAL DISPOSAL OF EXCESS MATERIAL NOT ACCEPTED BY THE PARK AND/OR UNSUITABLE MATERIALS AS NECESSARY IN ACCORDANCE WITH ALL FEDERAL, STATE, AND LOCAL REQUIREMENTS. ALL COST FOR RECYCLING, TRANSPORTING TO, PROCURING AND UTILIZING THE OFF-SITE SPOIL AREAS ARE TO BE INCIDENTAL TO THE CONTRACT.
- 10. IN CASE OF CONFLICT BETWEEN THE "MANUFACTURER'S RECOMMENDATIONS" FOR AN APPROVED MATERIAL AND THE GOVERNING "CONTRACT SPECIFICATIONS" FOR THE MATERIAL, THE MORE RESTRICTIVE OF THE TWO SHALL PREVAIL, UNLESS OTHERWISE
- 11. THE CONSTRUCTION PLANS PRESENT A CONCEPT OF THE RELATIONSHIP BETWEEN TRAFFIC CONTROL, EROSION CONTROL, ETC ANY REVISION TO THE DETAILS OR SEQUENCE SHOWN ON THE CONSTRUCTION PLANS SHALL BE PREPARED BY THE CONTRACTOR ON STANDARD DNRFC PLAN SHEETS AND SUBMITTED FOR REVIEW AND APPROVAL BY THE ENGINEER. THE PLANS SHALL BE PREPARED IN ACCORDANCE WITH CURRENT DNREC STANDARDS FOR TRAFFIC CONTROL, EROSION AND SEDIMENT CONTROL (PREPARED BY A CERTIFIED CONSTRUCTION REVIEWER), STORM WATER MANAGEMENT, ETC. AND SHALL BE SIGNED AND SEALED BY À PROFESSIONAL ENGINEER REGISTERED IN THE STATÉ OF DELAWARE. ALL REQUIRED CALCULATIONS, REPORTS, ETC. SHALL ALSO ACCOMPANY THE SUBMISSION. THE NUMBER OF COPIES REQUIRED TO BE SUBMITTED FOR REVIEW SHALL BE DETERMINED BY DNREC, DEPENDING ON THE NATURE OF THE PROPOSED REVISION. THE CONTRACTOR SHALL NOTE THAT THE REVISIONS TO THE CONSTRUCTION PLANS, AS WELL AS REVIEW TIME BY DNREC, WILL NOT JUSTIFY A DELAY IN THE CONSTRUCTION SCHEDULE. REVISIONS INVOLVING UTILITIES WILL REQUIRE THE COMPLETION OF A UTILITY STATEMENT APPROVED BY THE RESPECTIVE UTILITIES AS PART OF THE PLAN DOCUMENTS. ALL COSTS INVOLVED IN PREPARING THE PLAN REVISIONS SHALL BE THE RESPONSIBILITY OF THE CONTRACTOR.
- 12. THESE DRAWINGS DO NOT INCLUDE NECESSARY ELEMENTS OF CONSTRUCTION SAFETY. ALL CONSTRUCTION, INCLUDING EXCAVATION, MUST BE COMPLETED IN ACCORDANCE WITH THE OCCUPATIONAL SAFETY AND HEALTH ACT, CFR \\$1926.652(b)(2), AND ALL FEDERAL, STATE AND LOCAL REQUIREMENTS. THE CONTRACTOR IS SOLELY RESPONSIBLE FOR ALL SITE SAFETY.
- 13. NO DEBRIS SHALL BE BURIED OR BURNED ON THE SITE UNLESS SPECIFICALLY NOTED WITHIN THESE PLANS OR SPECIFICATIONS.

COUNTY TAX MAP:

ADDRESS OF SITE:

5. ZONING:

LOT AREA:

7. SOURCE OF TITLE:

8. EXISTING USE:

10. DATUM:

9. PROPOSED USE:

11. FLOOD PLAIN MAP

AREA. (BFE = 17.43 FEET)

16. OWNER/DEVELOPER: STATE OF DELAWARE

2. DNREC PROJECT NUMBER: KPSP-28

DESCRIPTION	EXISTING	PROPOSED
CONTOUR	— — -10- — — —	
GUARDRAIL		N/A
SIGN	 	N/A
WOODEN BOLLARD		N/A
DOCK/PIER/ELEVATED WALKWAY	N/A	
TREE		N/A
FENCE	<u> </u>	<u> </u>
WOODSLINE		N/A
PROPERTY LINE/RIGHT OF WAY		N/A
ORDINARY HIGH WATER LINE	—— онw ——— онw ———	N/A
SOIL STOCKPILE AREA	N/A	———— SP ————
LIMITS OF DISTURBANCE/ LIMITS OF CONSTRUCTION	N/A	LOD-LOC
GRAVEL TRAIL	N/A	
BOLLARD	N/A	\Diamond
SPAN IDENTIFICATION NO.	N/A	9
TEST PILE	N/A	$oldsymbol{\otimes}_{TP}$
PRODUCTION PILE	N/A	$oldsymbol{\otimes}_{TP}$
AREA OF DEMOLITION	N/A	

LEGEND

NOTE: REFER TO THE SEDIMENT & STORMWATER MANAGEMENT PLANS FOR ADDITIONAL LEGEND INFORMATION

SPECIFICATIONS IVIL ELEMENTS UNDER THIS CONTRACT SHALL BE CONSTRUCTED UTILIZING THE FOLLOWING

- . CONTRACT AGREEMENT BETWEEN OWNER AND CONTRACTOR.
- EROSION AND SEDIMENT CONTROL HANDBOOK, APRIL 2014 OR MOST CURRENT AT DATE OF
- 5. DELAWARE DEPARTMENT OF TRANSPORTATION STANDARD CONSTRUCTION DETAILS, 2017, OR MOST CURRENT AT ADVERTISEMENT.

FIRE MARSHAL NOTES NAME OF PROJECT: KILLENS POND STATE PARK ELEVATED WALKWAY 5025 KILLENS POND ROAD ADDRESS: FELTON, DE 19943 TAX MAP NUMBER: 8-00-149.00-01-13.00-000 8-00-149.00-01-15.00-0000 6-00-149.00-01-19.00-0000

6-00-149.00-01-44.00-0000

MULTI-USE ELEVATED WALKWAY

NONE

NONE

NONE

N/A

N/A

N/A

N/A

NONE

OWNER'S NAME AND ADDRESS: STATE OF DELAWARE DELAWARE STATE PARKS CENTURY ENGINEERING, INC. ENGINEER: 4134 N. DUPONT HWY.

DOVER, DE 19901 PER FIRM MAP NUMBER 10001C0335J, DATED JULY 7, 2014, THIS SITE LIES WITHIN ZONE AE, WALTER J. HOEY, III, P.E. (CENTURY ENGINEERING, INC.)

INTENDED USE OF SITE:

NUMBER OF FIRE HYDRANTS

MAXIMUM HEIGHT OF BUILDING:

PROPOSED BUILDING CONSTRUCTION;

AUTOMATIC SPRINKLER PROTECTION:

WATER SUPPLIER:

BUILDING USE:

BUILDING(S) SIZE:

FIRE LANES:

12. WATER RESOURCE PROTECTION THIS SITE DOES NOT LAY WITHIN A RECHARGE WATER RESOURCE PROTECTION AREA.

THE TOTAL LAND DISTURBANCE PROPOSED BY THIS PLAN IS 0.49± ACRES (21,249± S.F.)

DATA COLUMN

LONGITUDE: 75.5229 W

37.68± ACS.

DEED RECORD/INSTRUMENT NUMBER

7-0023-0536

7-0023-0536

Z-0023-0536

2.57± ACS.

8.08± ACS.

8-00-149.00-01-13.00-00001

8-00-149 00-01-15 00-00001 6-00-149 00-01-19 00-00001

6-00-149.00-01-44.00-00001

EXISTING: AC-AGRICULTURAL CONSERVATION

PROPOSED: AC-AGRICULTURAL CONSERVATION

<u>TAX_PARCEL_NO.</u> 8-00-149.00-01-13.00-0000

8-00-149.00-01-15.00-0000

6-00-149.00-01-19.00-0000

TAX PARCEL NO. 8-00-149.00-01-13.00-0000

8-00-149 00-01-15 00-0000

6-00-149.00-01-19.00-0000

6-00-149.00-01-44.00-0000

6-00-149.00-01-44.00-0000 87.7± ACS.

STATE PARK WITH PEDESTRIAN IMPROVEMENTS

5025 KILLENS POND ROAD

FELTON, DE 19943

SITE COORDINATES AT CENTER OF PROJECT SITE: LATITUDE: 38.9816 N

STATE PARK

VERTICAL - NAVD 88

HORIZONTAL – NAD 83

THE TOTAL LIMITS OF CONSTRUCTION FOR THE SITE IS 0.49± ACRES (21,249± S.F.)

15. LENGTH OF PROPOSED TRAIL: 868 LINEAR FEET (0.164 MILES).

DNREC, DIVISION OF PARKS & RECREATION 89 KINGS HIGHWAY, DOVER, DE 19901 PHONE: 302-739-9210 FAX: 302-739-3817

17. REVIEW AGENCY: DNREC. DIVISION OF WATERSHED STEWARDSHIP 89 KINGS HIGHWAY, DOVER, DE 19901 PHONE: (302) 739-9921 FAX: (302) 739-6724

18. CIVIL ENGINEER: CENTURY ENGINEERING, INC. 4134 NORTH DUPONT HIGHWAY, DOVER, DE 19901 ALEX SCHMIDT, P.E. PHONE: (302) 734-9188

FAX: (302) 734-4589

- NFORMATION IN THE HIERARCHY LISTED BELOW:
- APPROVED PLANS.
- 1. STATE OF DELAWARE DEPARTMENT OF NATURAL RESOURCES AND ENVIRONMENTAL CONTROL
- DELAWARE DEPARTMENT OF TRANSPORTATION STANDARDS AND SPECIFICATIONS FOR BRIDGE AND ROAD CONSTRUCTION, 2016, OR MOST CURRENT AT DATE OF ADVERTISEMENT.

NO. 11204

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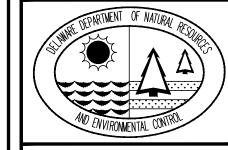
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 \Box

<u>/IL ENGINEER:</u>

CENTURY ENGINEERIN CONSULTING ENGINEERS. SURVEYORS 4134 N. DUPONT HWY. DOVER, DELAWARE 19901

CEI CONTRACT NO.: 175013.11



JSW

DESIGNED BY:

DRAWN BY:

CHECKED BY:

1. ALL FIRE LANES, FIRE HYDRANTS, AND FIRE DEPARTMENT CONNECTIONS SHALL BE MARKED IN ACCORDANCE WITH THE STATE FIRE PREVENTION REGULATIONS.

ALL PROPOSED FIRE HYDRANTS AND WATER MAINS SHALL BE INSTALLED IN ACCORDANCE WITH THE MOST CURRENT EDITION OF THE DELAWARE STATE FIRE REGULATIONS. (DSFPR REGULATION 702, CHAPTER 6 & 7.

FIRE HYDRANTS SHALL BE COLOR CODED IN ACCORDANCE WITH THE DSFPR REGULATION 703, CHAPTER 3, SECTION 4. THIS INCLUDES BOTH COLOR CODING THE BONNET AND 2 INCH REFLECTIVE TAPE AROUND THE BARREL UNDER THE TOP FLANGE. ALL THREADS PROVIDED FOR FIRE DEPARTMENT CONNECTIONS, TO SPRINKLER SYSTEMS,

STANDPIPES, YARD HYDRANTS OR ANY OTHER FIRE HOSE CONNECTIONS SHALL BE UNIFORM TO

THOSE USED BY THE FIRE DEPARTMENT IN WHOSE DISTRICT THEY ARE LOCATED. (DSFRP


REGULATION 703, CHAPTER 1, SECTION 1.5) 5. THE STEAMER CONNECTION OF ALL FIRE HYDRANTS SHALL BE SO POSITIONED SO AS TO BE

AUGUST 2020 NONE SHEET NO.:

FACING THE STREET OR FIRE LANE. (DSFPR REGULATION 705, CHAPTER 5, SECTION 10)

2020-KP-100

CONTRACT NO .:

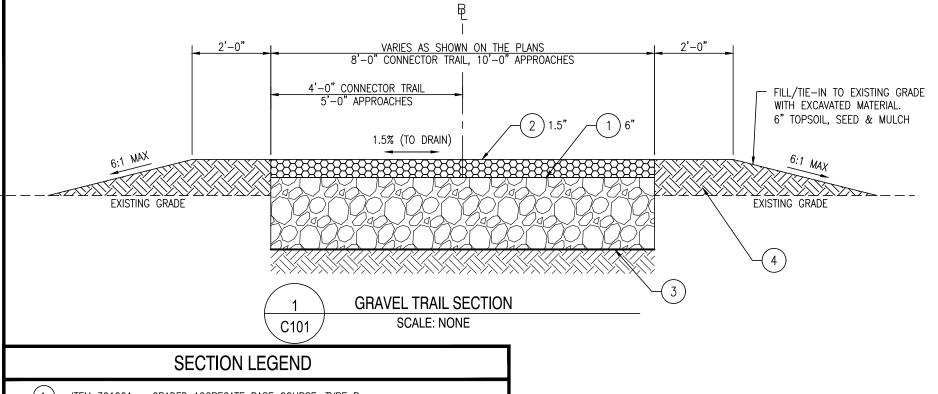

(1) ITEM 301001 - GRADED AGGREGATE BASE COURSE, TYPE B

THESE ITEMS.

(2) ITEM 302004 - DELAWARE NO. 10 STONE (STONE DUST) (3) ITEM 708002 - SEPARATION GEOTEXTILE BETWEEN PREPARED SUBGRADE AND GABC

(4) ITEM 908004 - TOPSOIL, 6" DEPTH. TO BE PLACED ON ITEM 209006 - BORROW, TYPE F, AS REQUIRED TO CONSTRUCT APPROACH. ITEM NUMBERS UTILIZE THE CURRENT 2016 DELDOT STANDARD SPECIFICATIONS. ITEM NUMBERS THAT HAVE A "O" FOR THE FOURTH DIGIT. REFER TO DELDOT "STANDARD

SPECIFICATIONS". IT IS THE CONTRACTOR'S RESPONSIBILITY TO OBTAIN THE DELDOT

STANDARD SPECIFICATIONS EITHER ONLINE OR HARD COPY FROM DELDOT TO REFERENCE


SUBGRADE SOILS SHALL BE LEVELED AND COMPACTED VIA MINIMUM TWO PASSES WITH A WALK BEHIND, DOUBLE DRUM ROLLER - VIBRATORY COMPACTOR PRIOR TO PLACEMENT OF GRADED AGGREGATE BASE COURSE, TYPE B.


2. SURFACE COURSE (DELAWARE #10 STONE) SHALL BE ROLLED INTO GABC BASE COURSE."


3. ELEVATED GRAVEL TRAIL SECTION SHOWN. GRAVEL TRAIL CONNECTION TO NATURE CENTER TRAIL SHALL BE AT-GRADE WITH NO INCREASE IN ELEVATION.


ABBREVIATIONS


ON CENTER

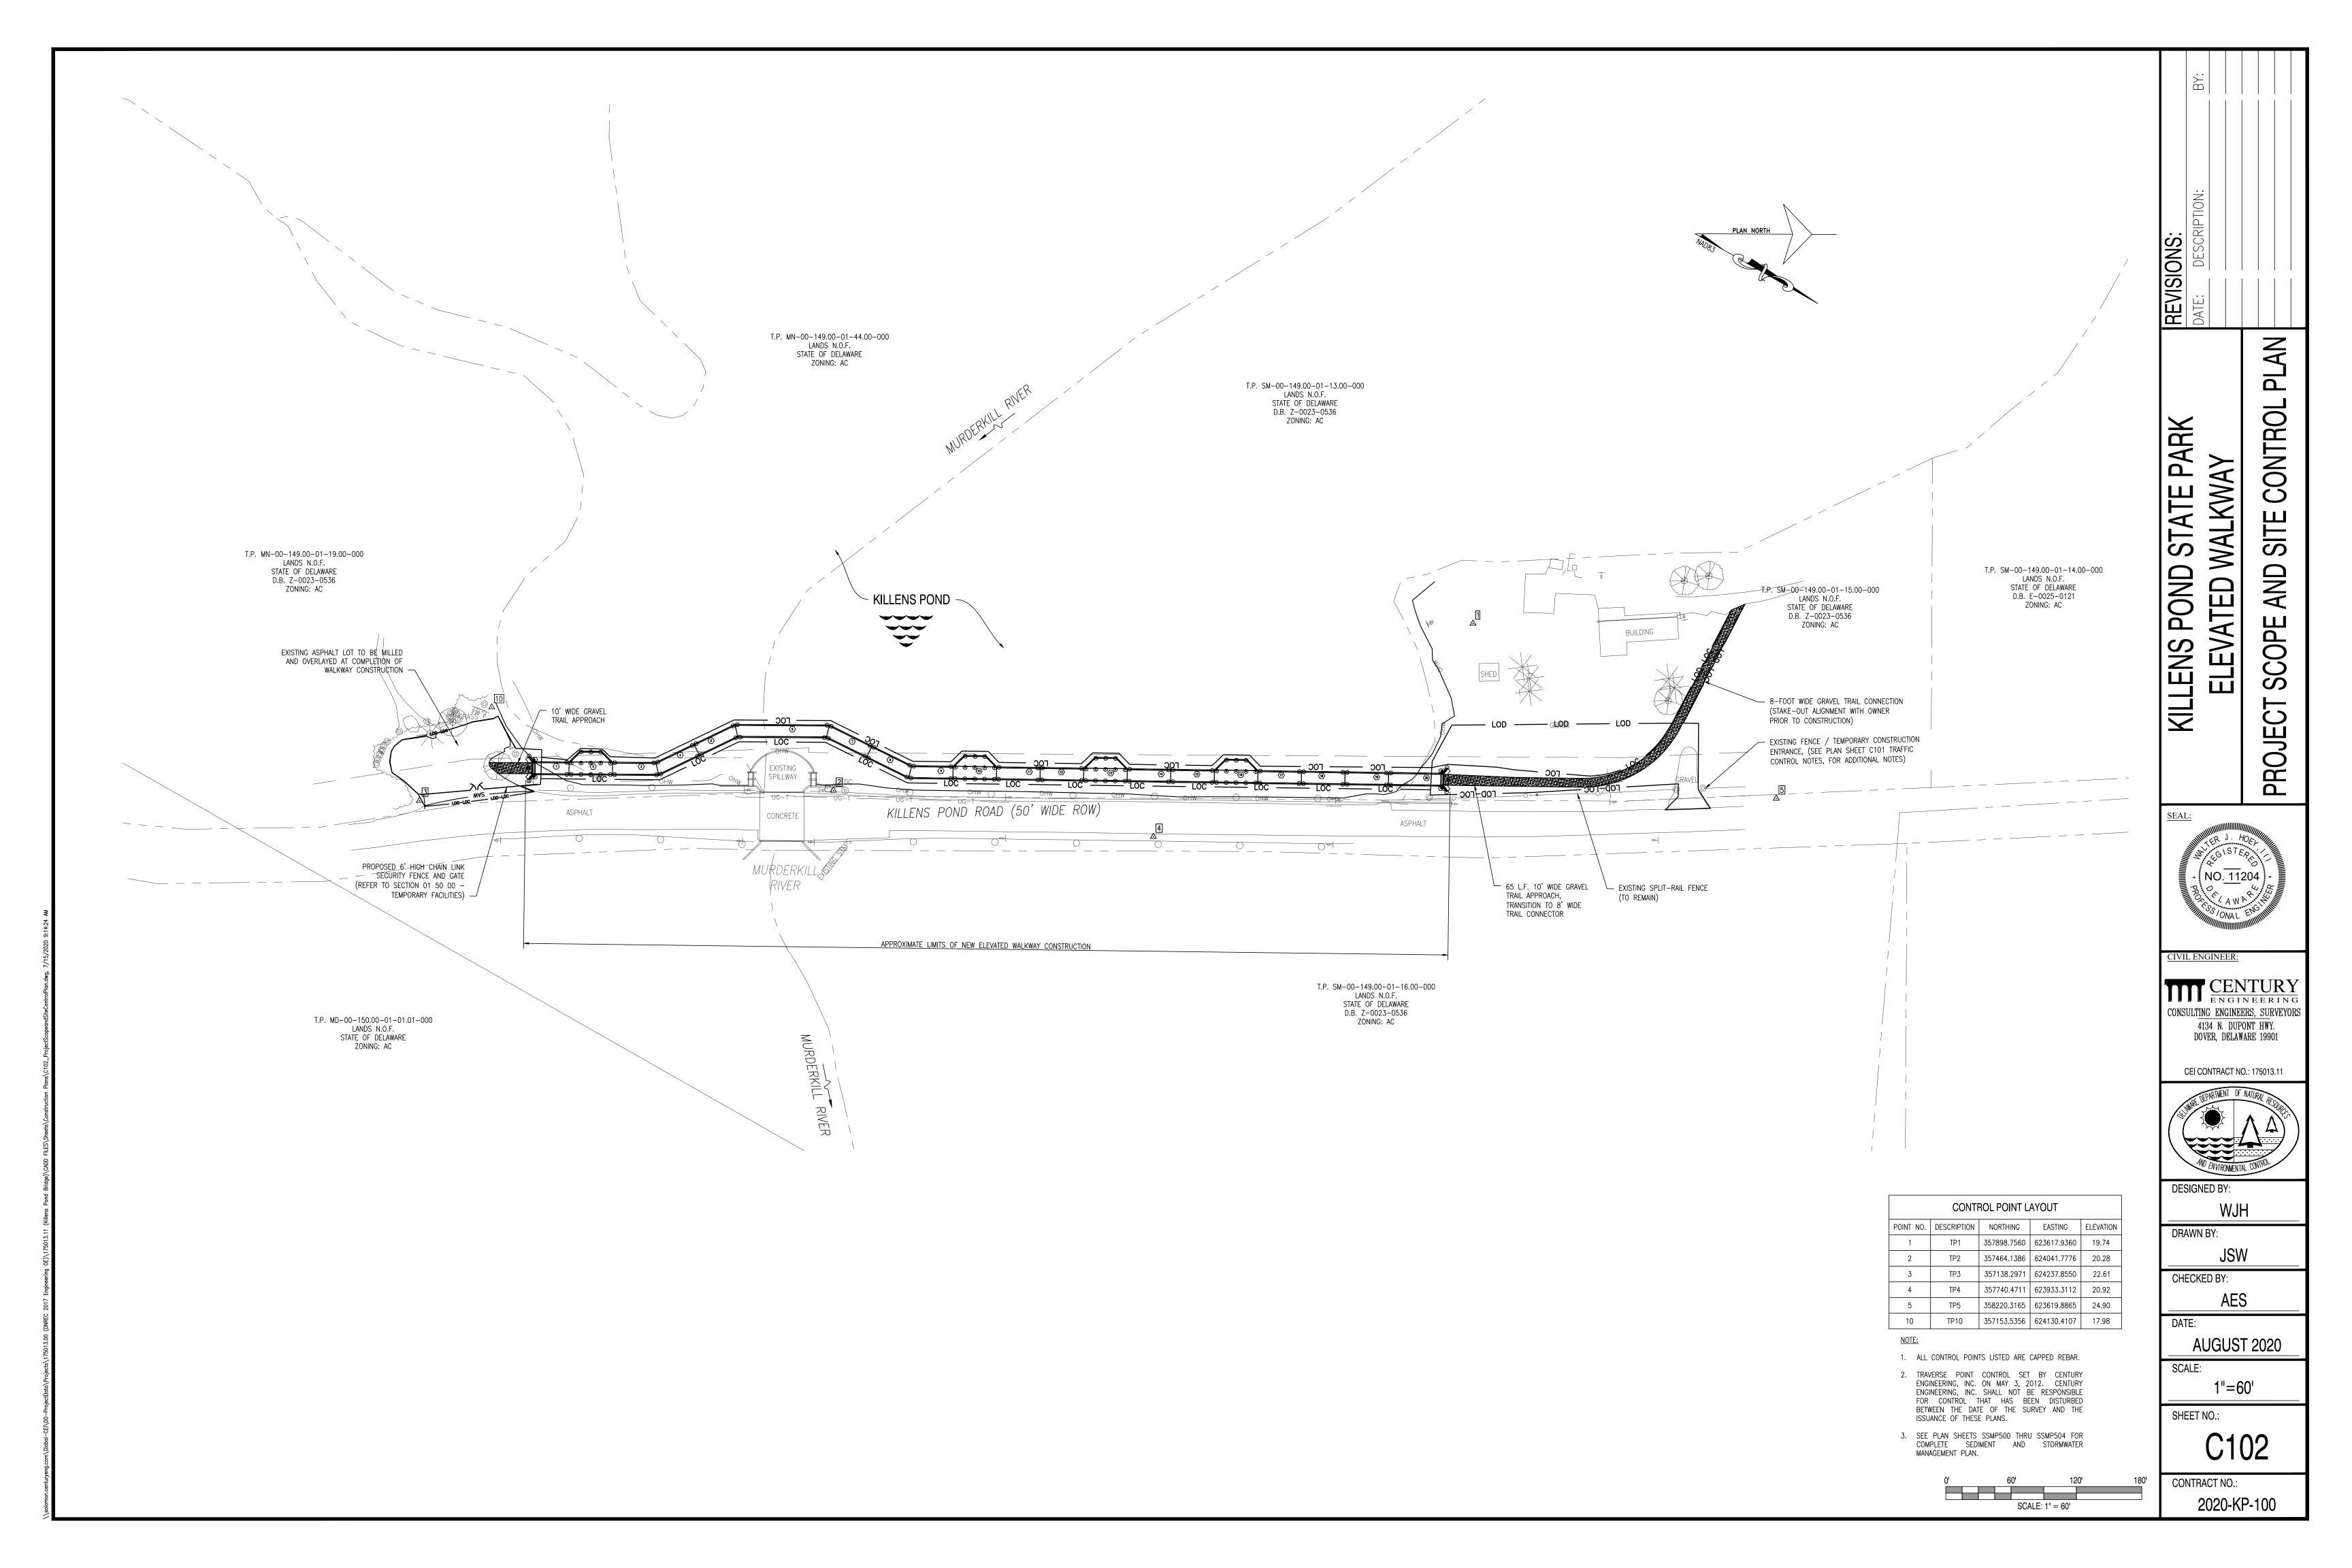


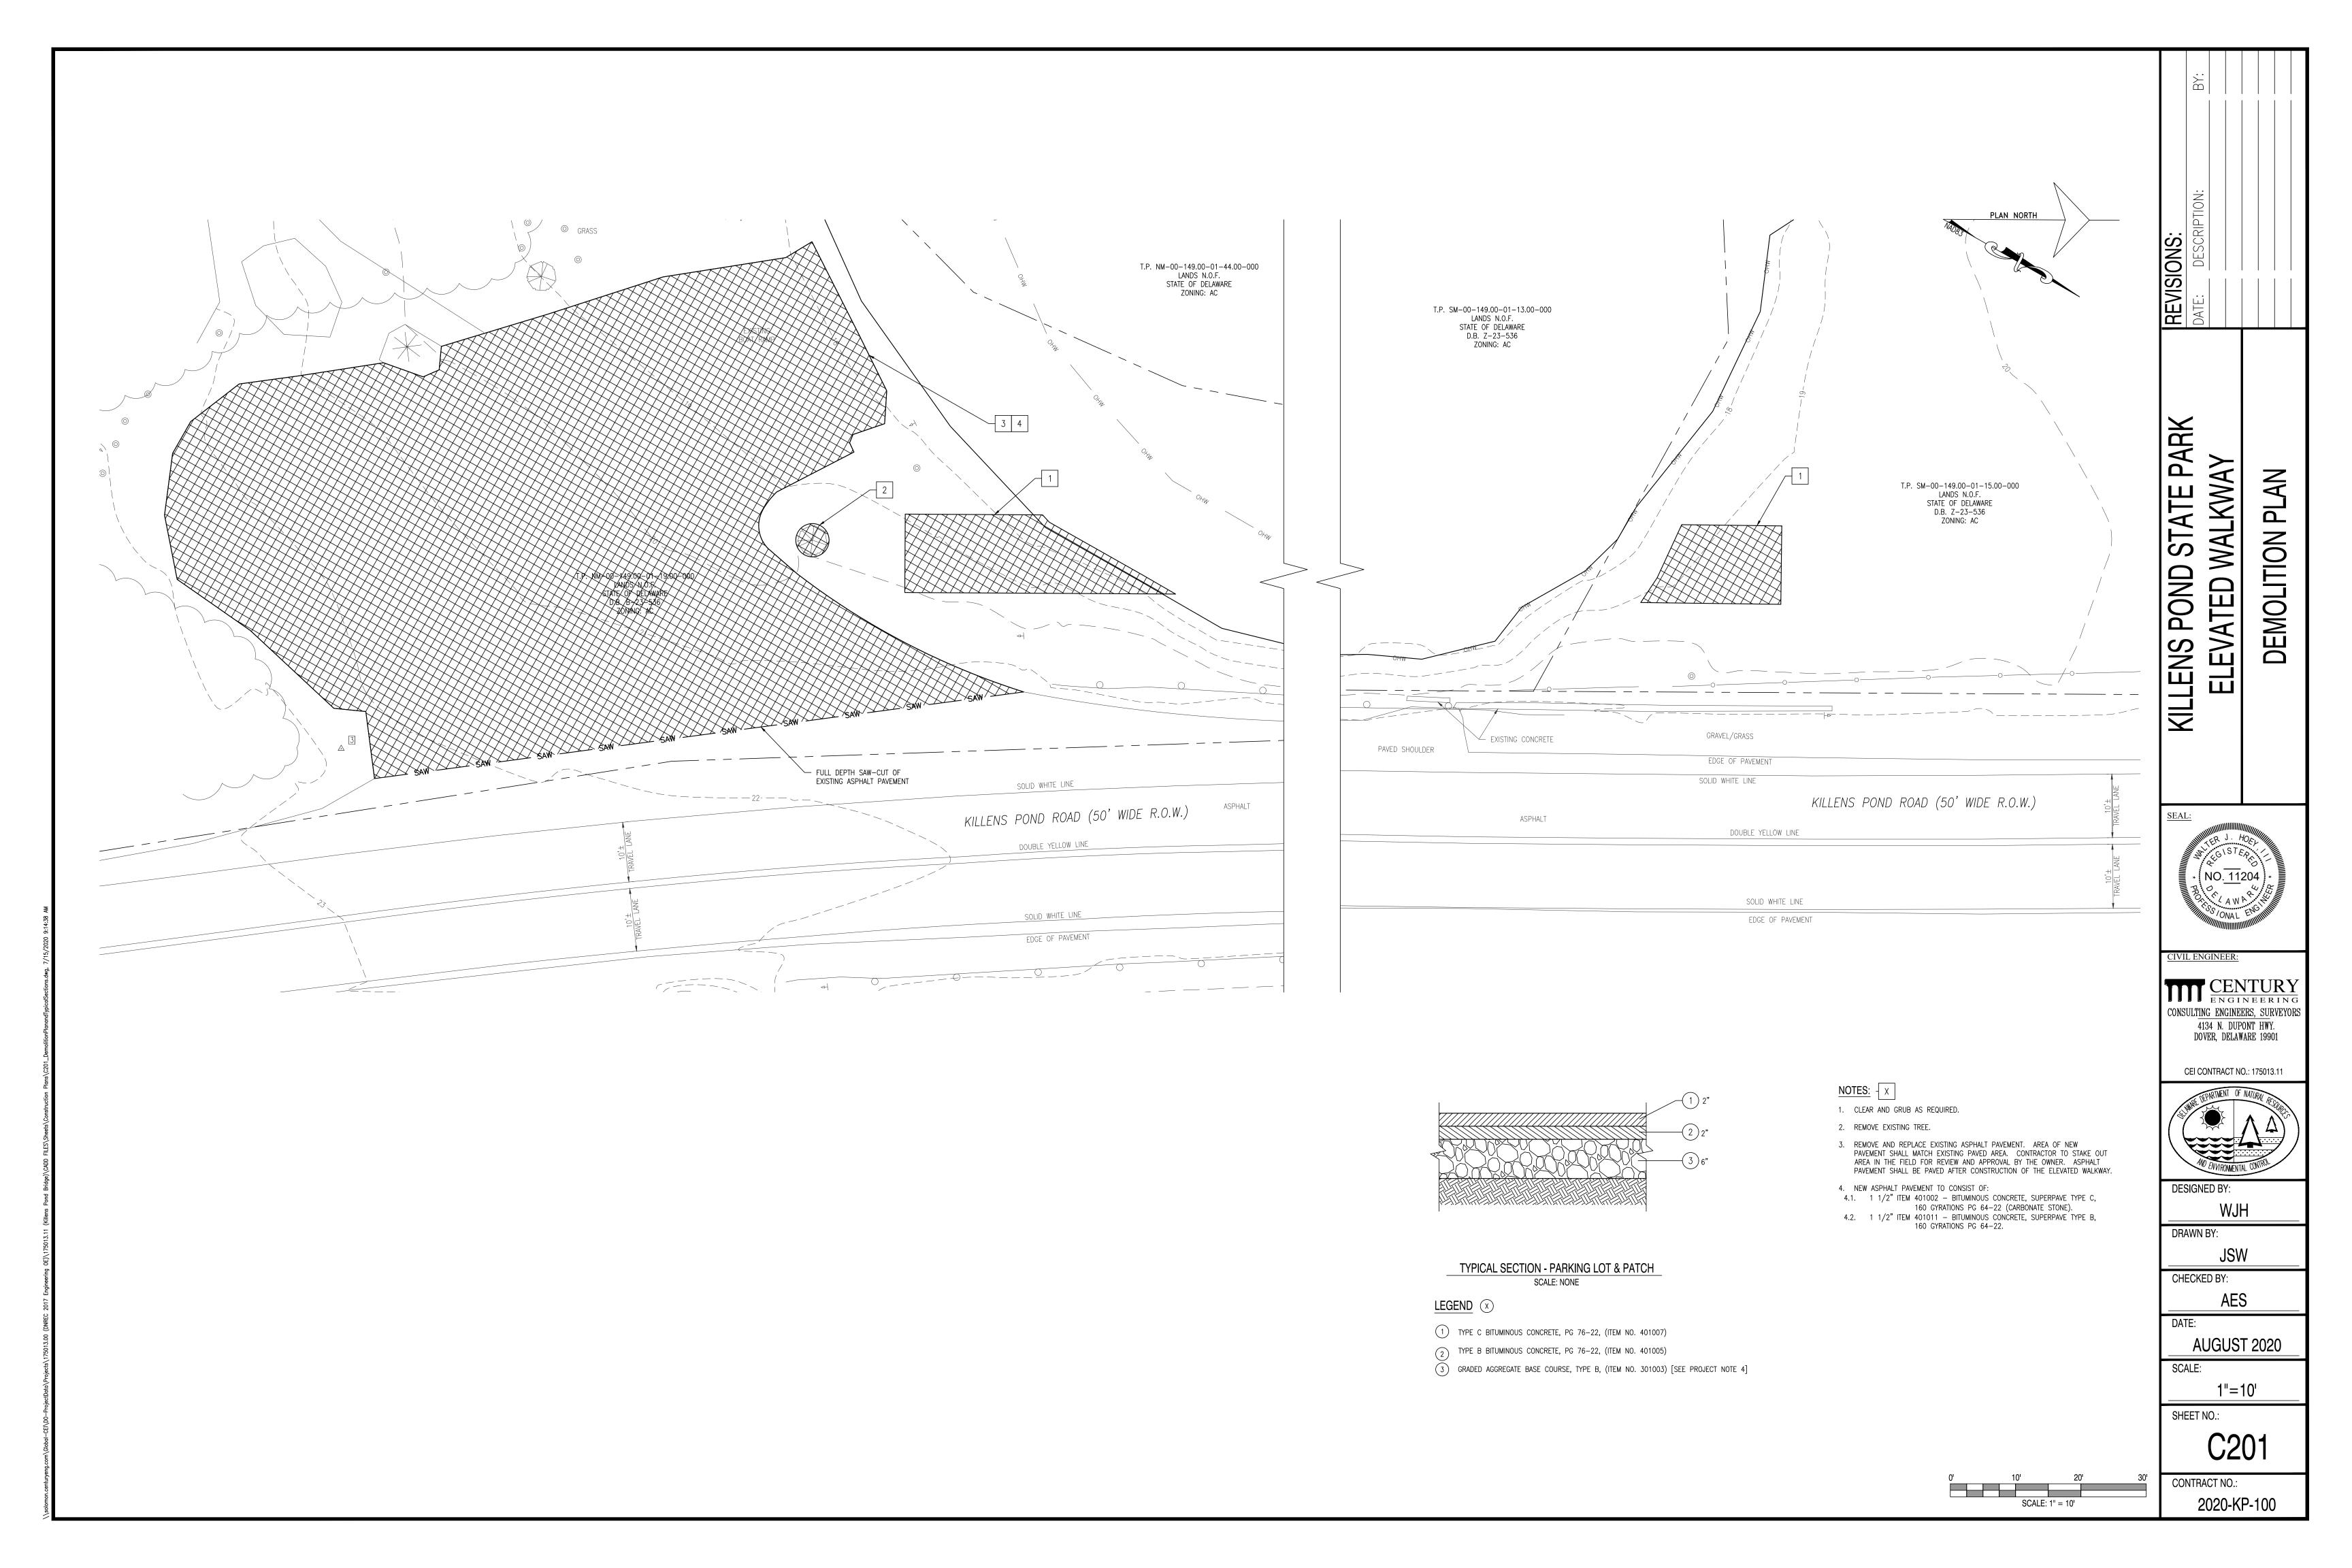


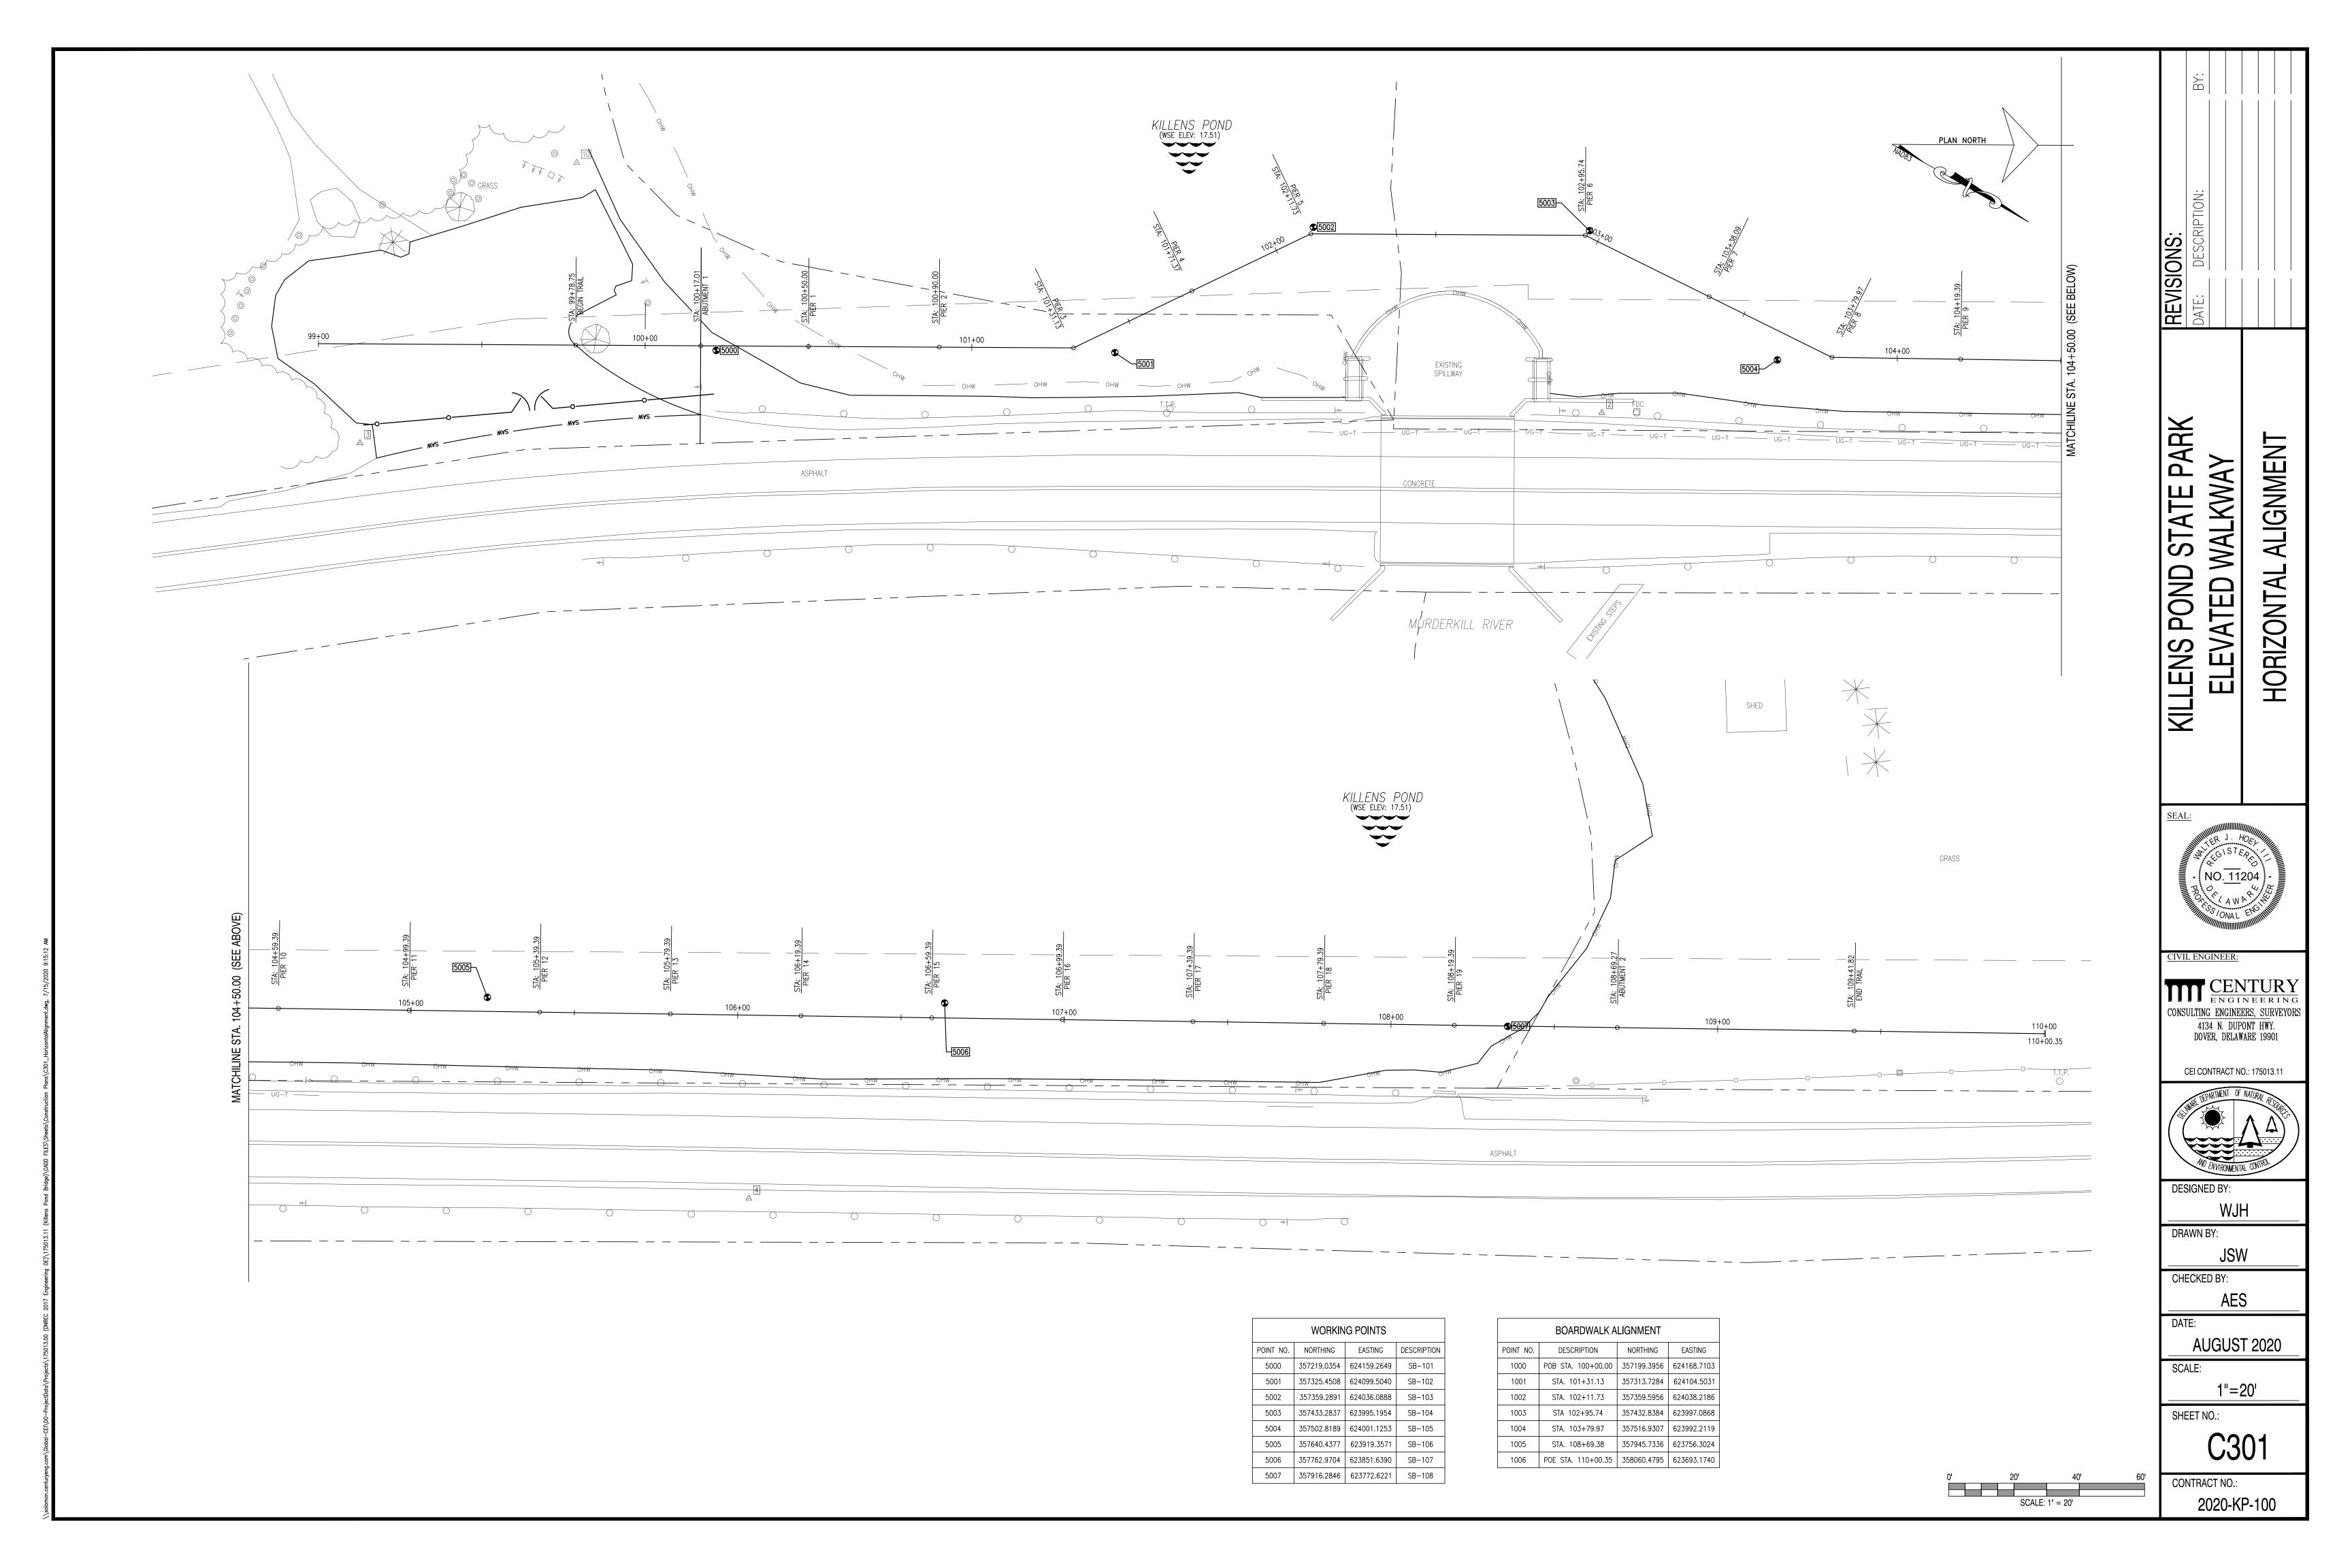


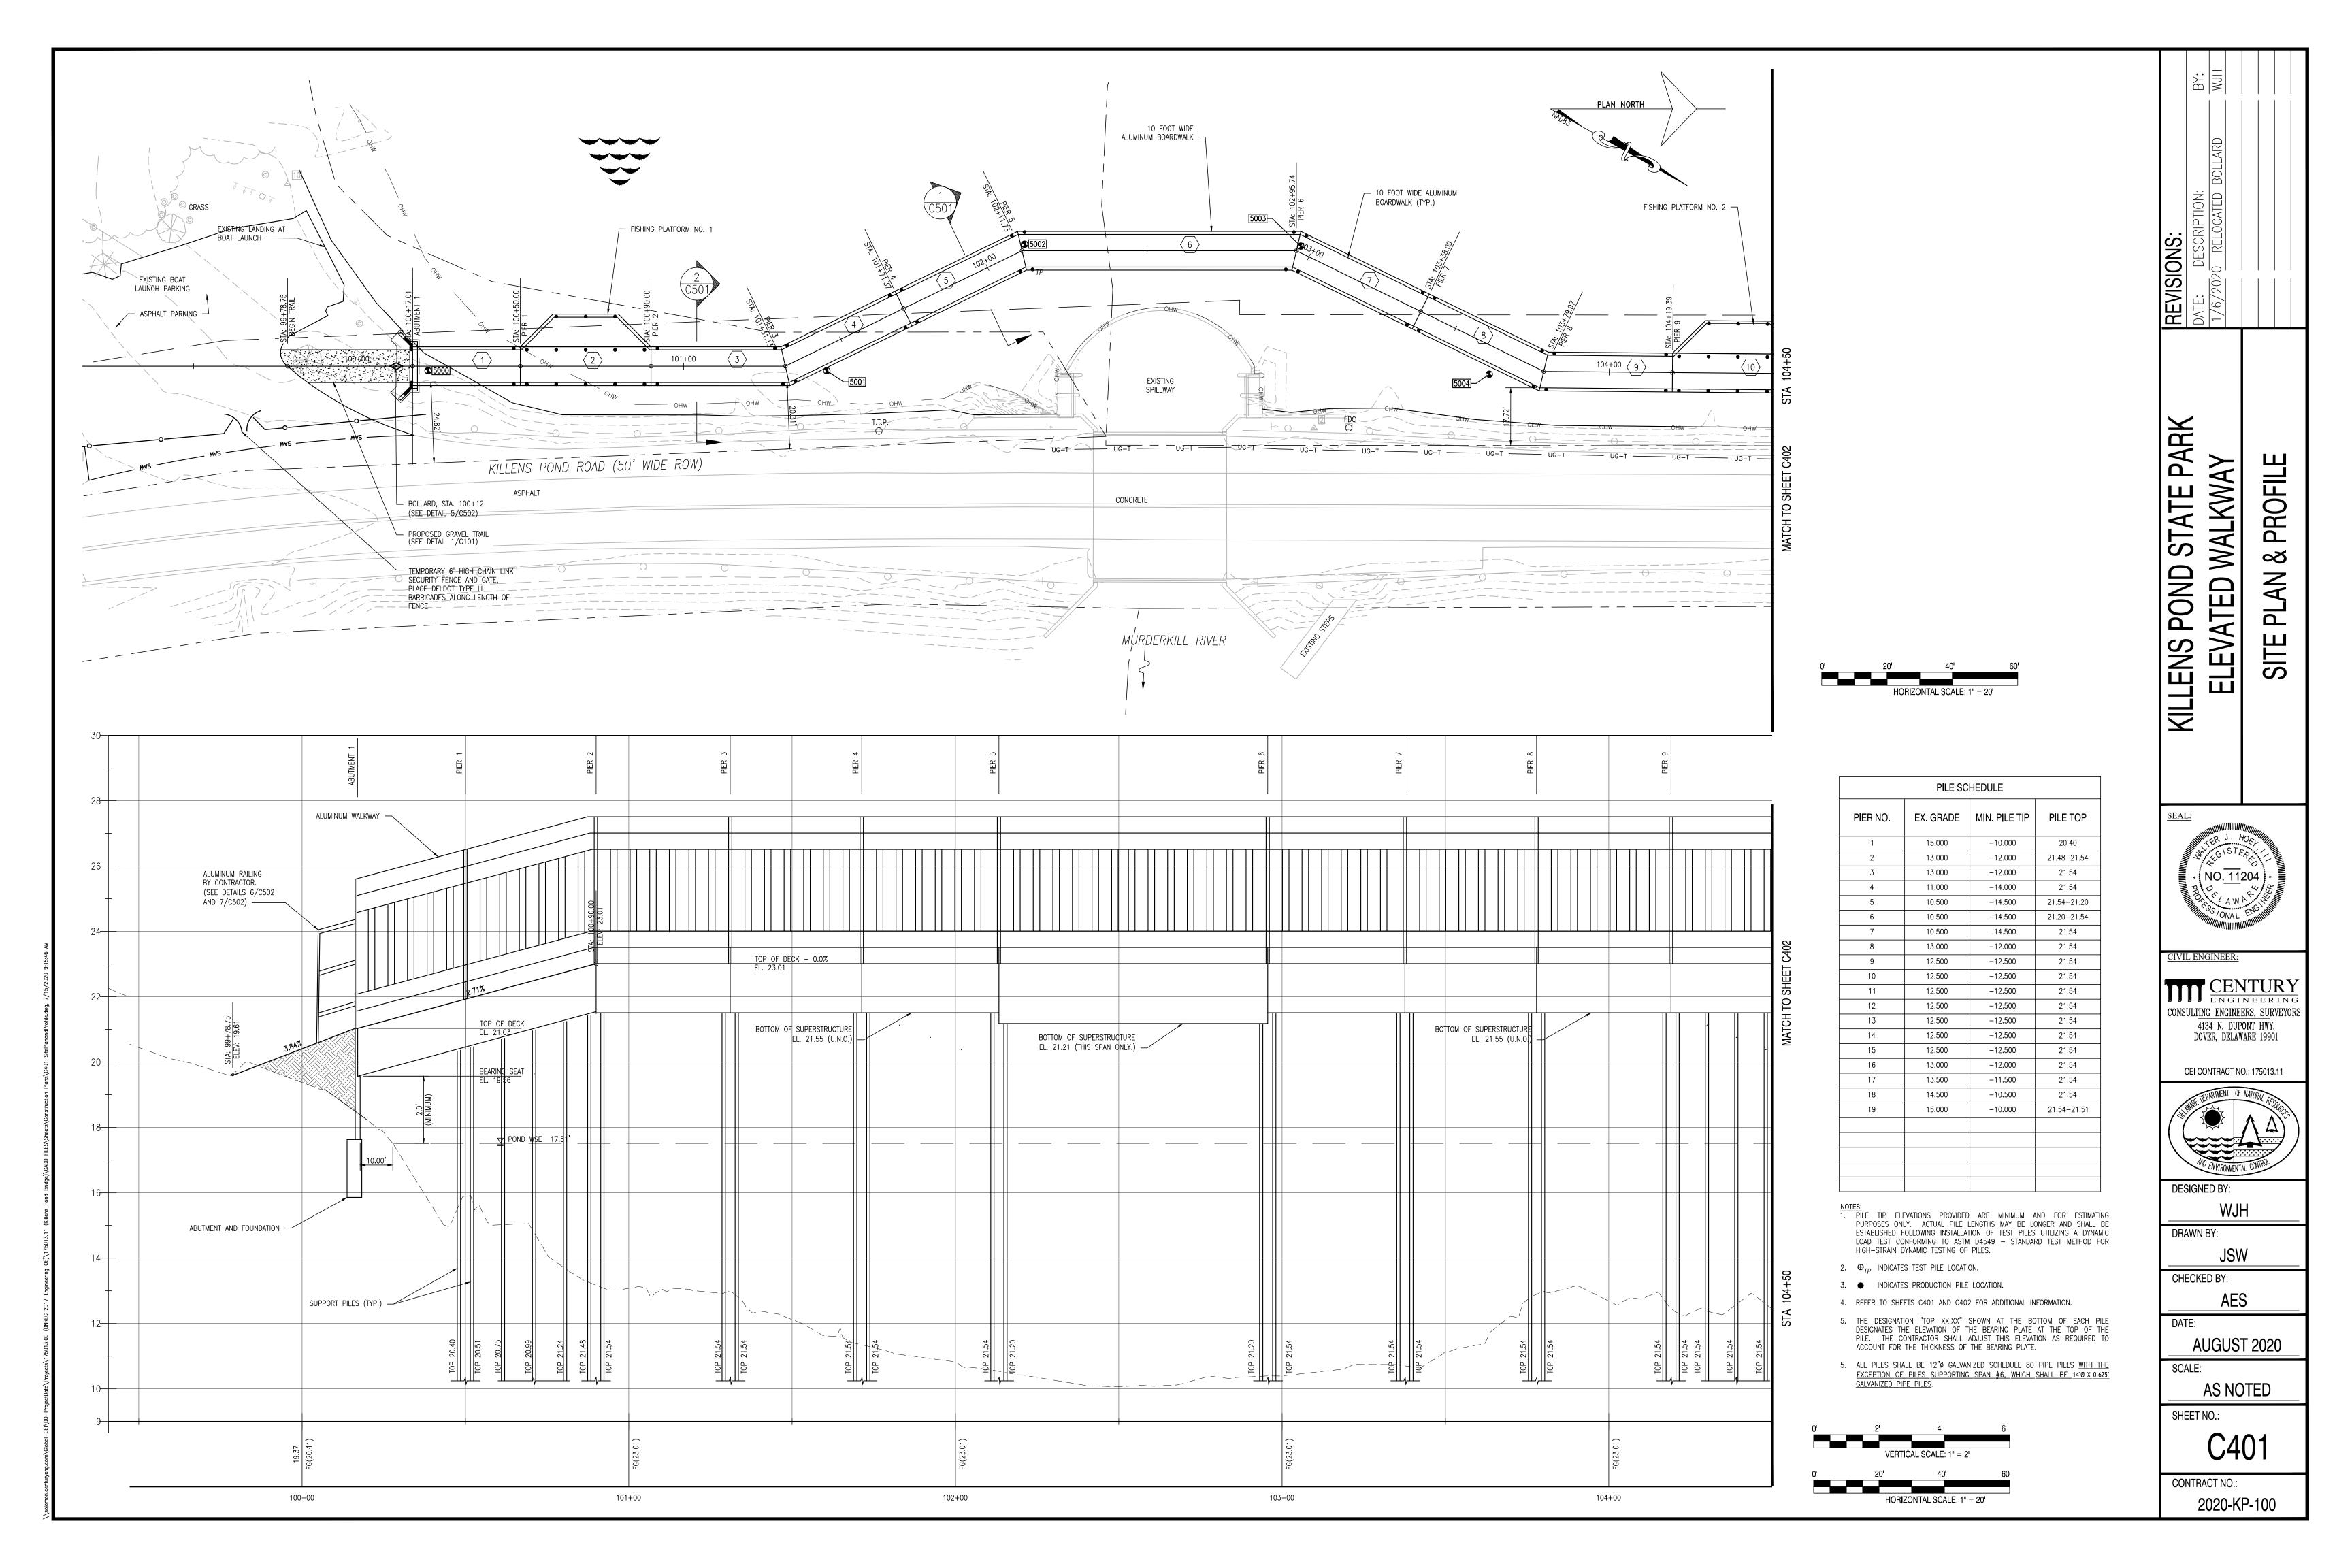

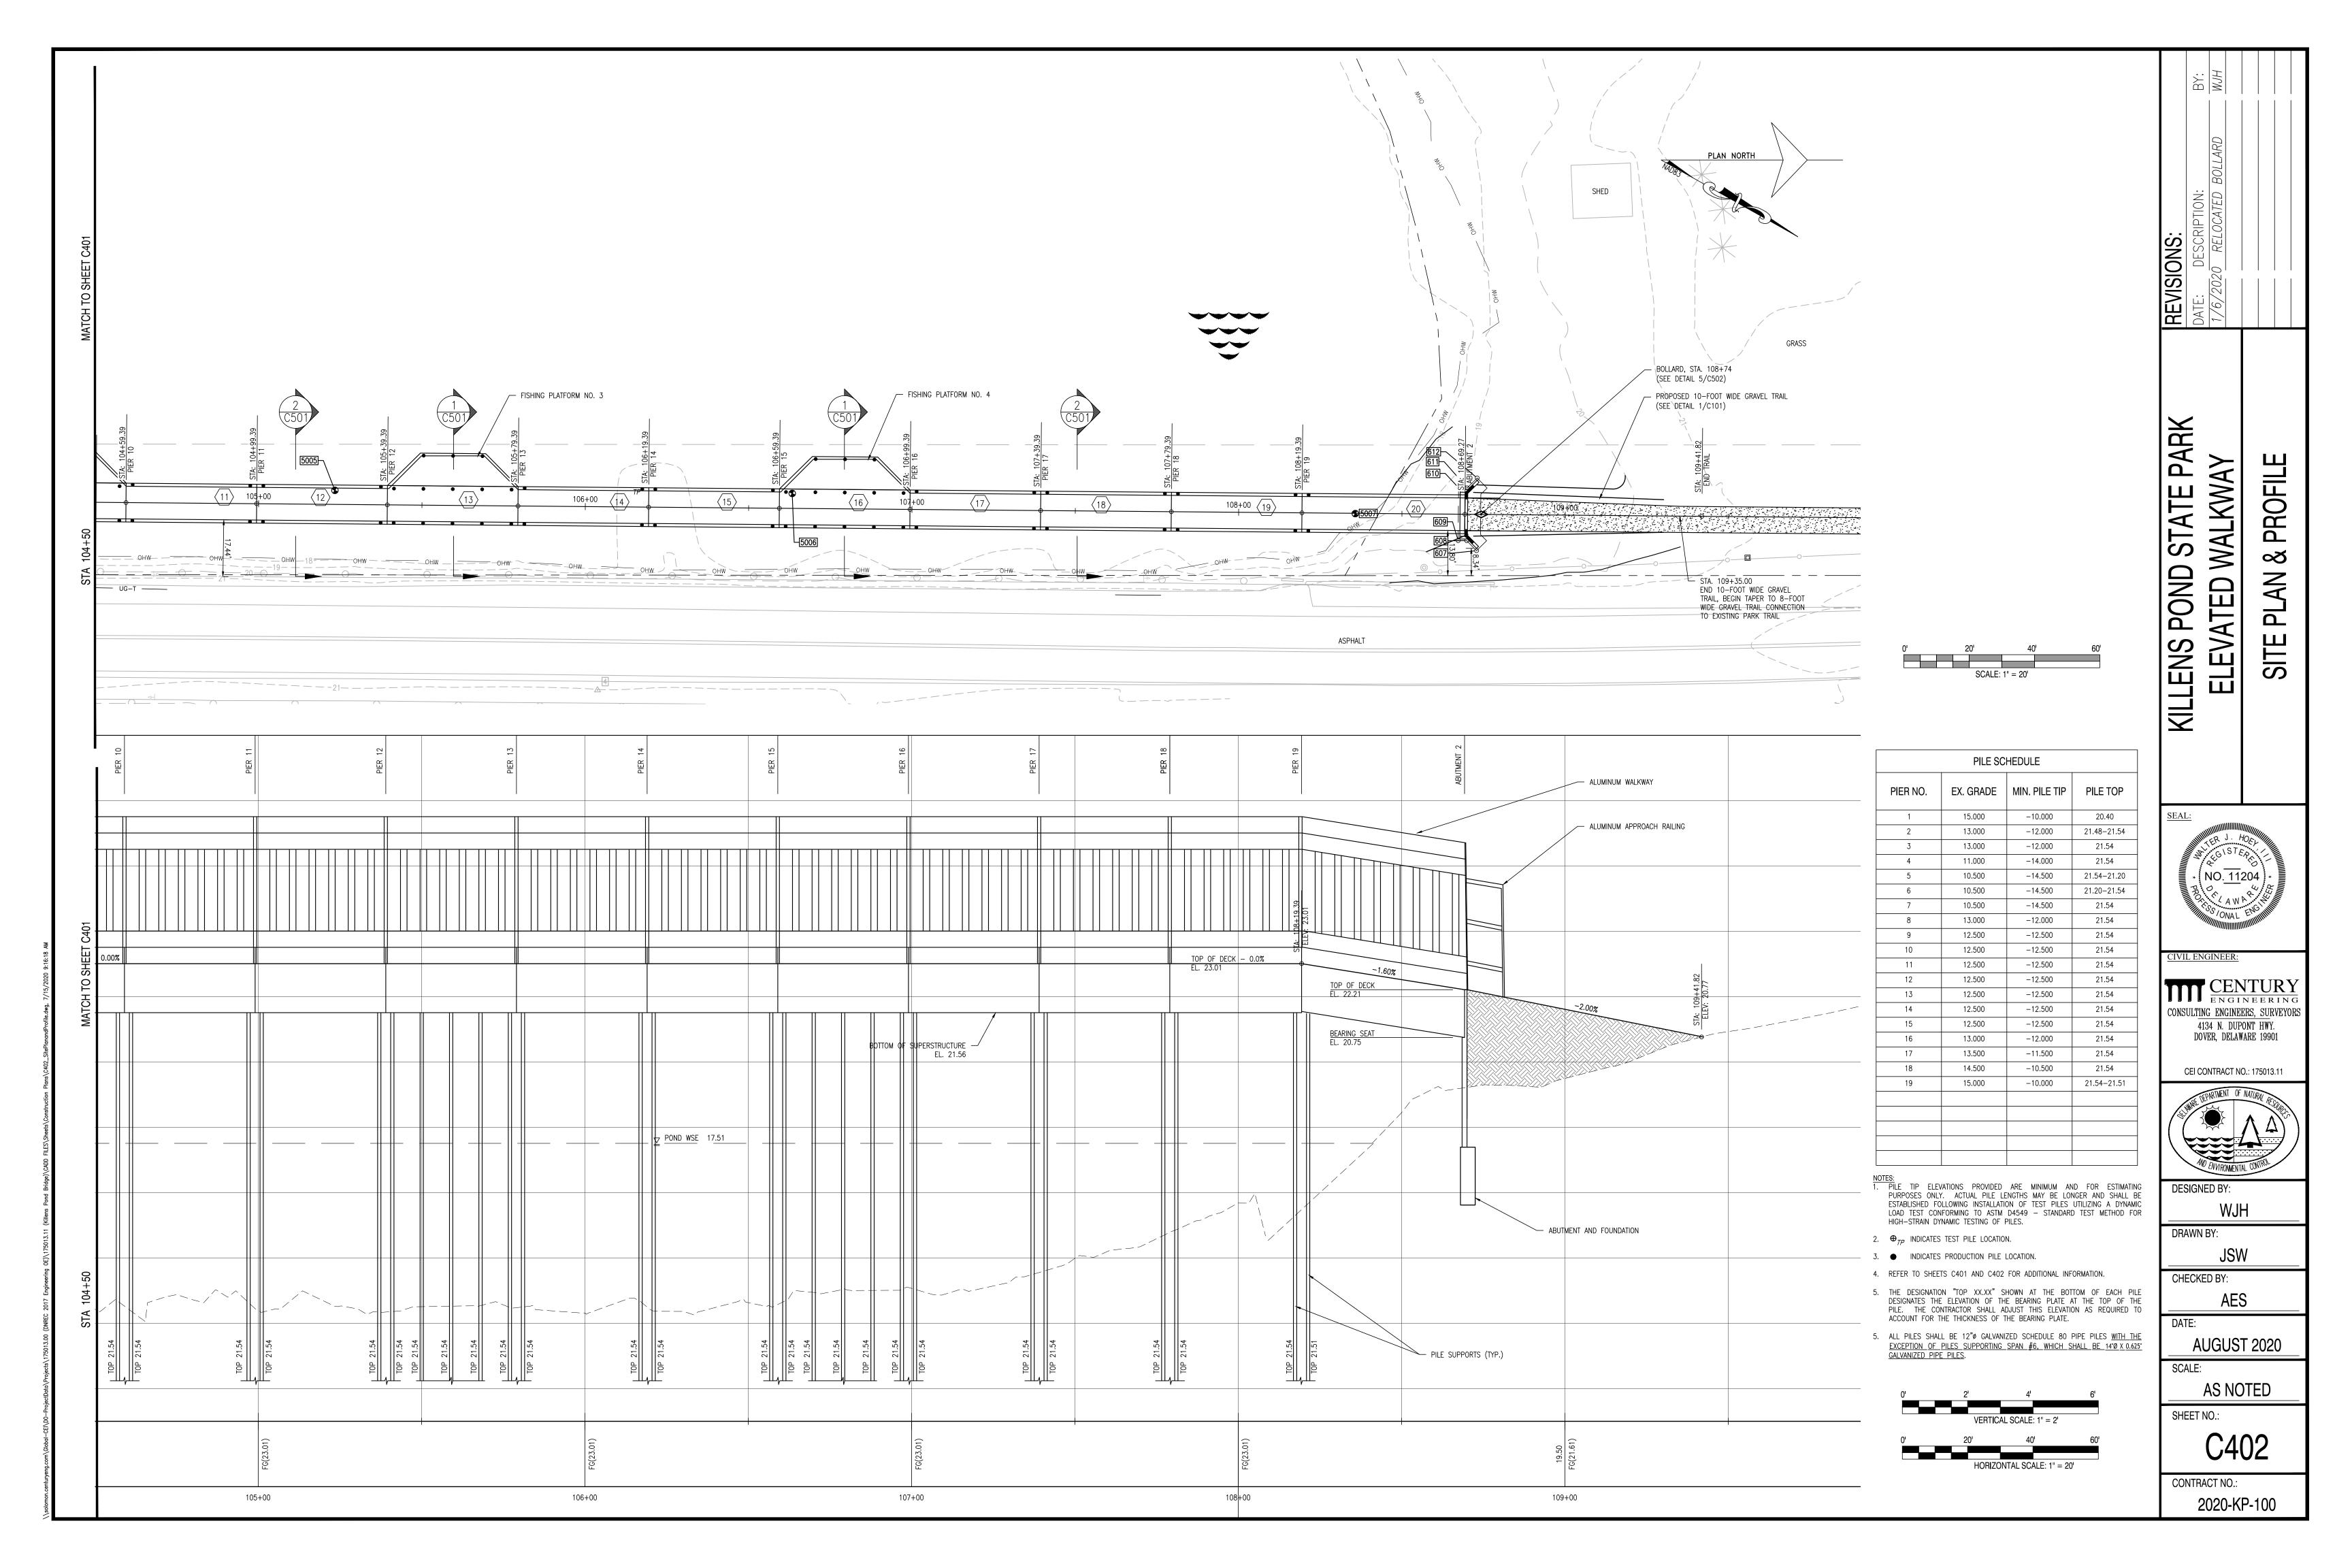

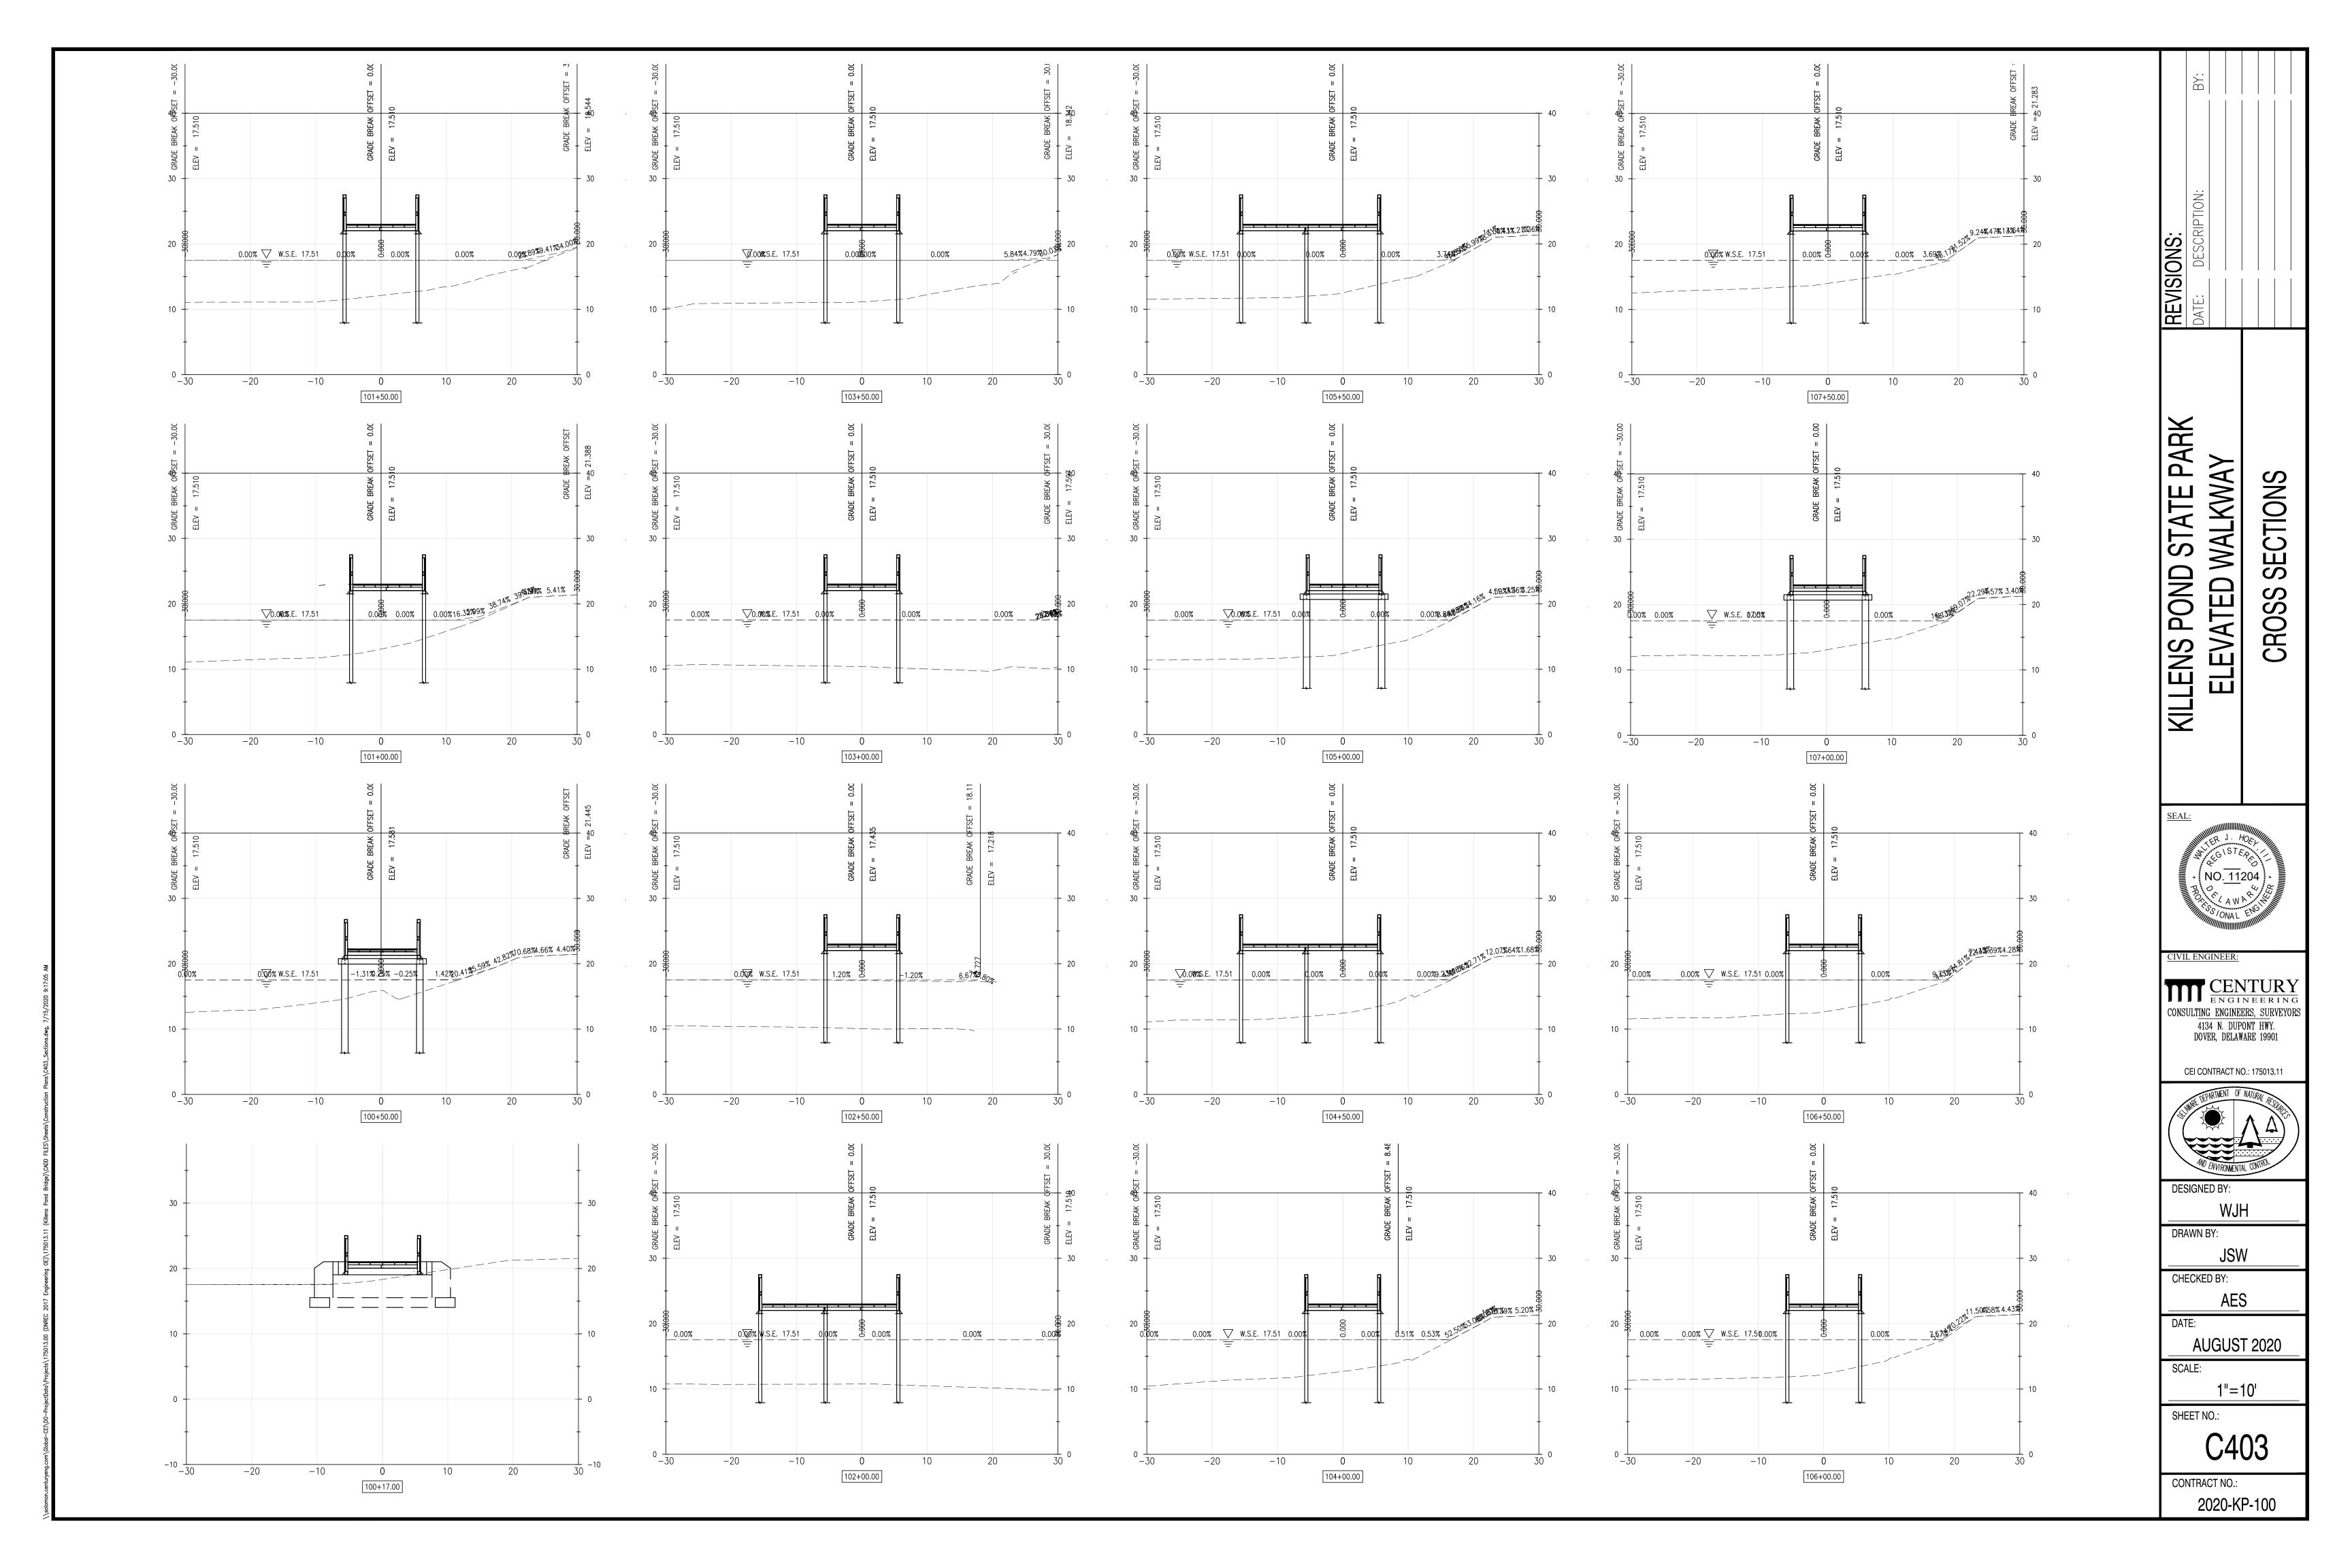

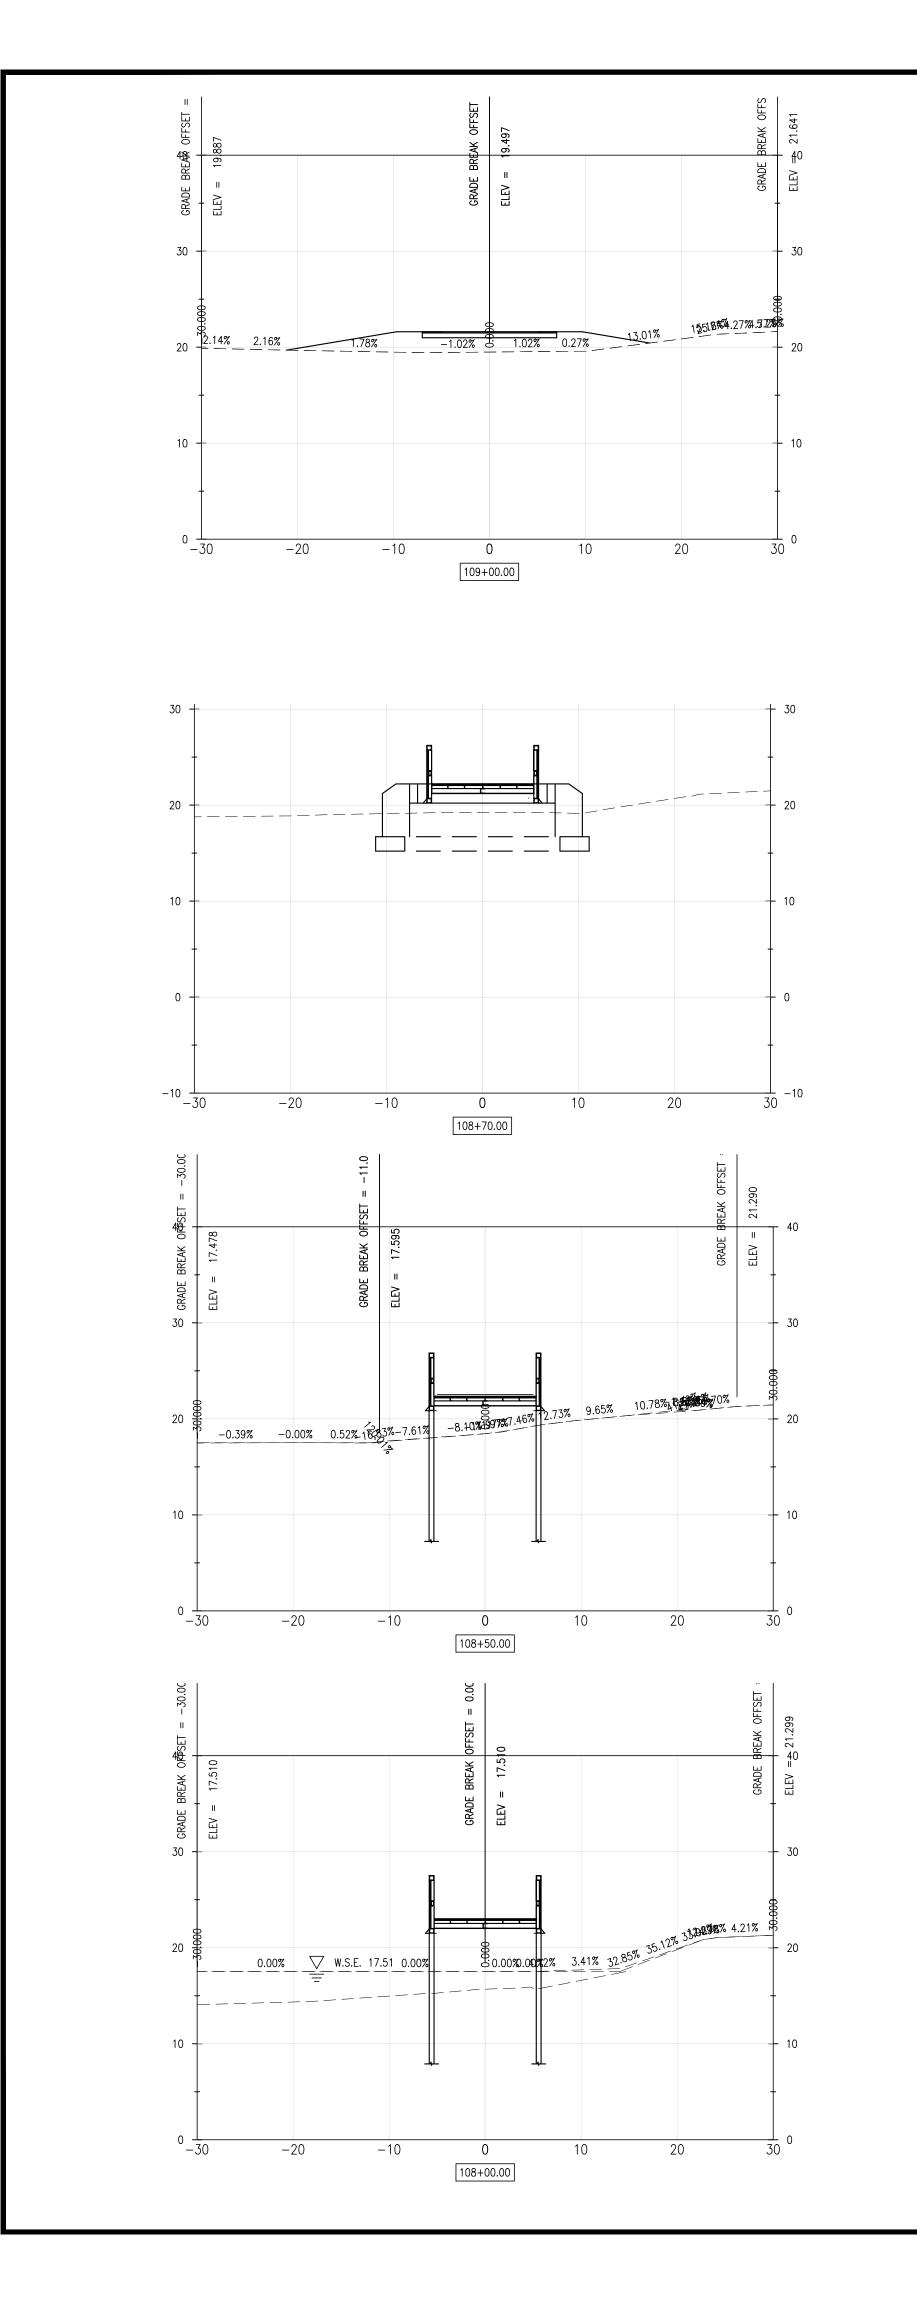

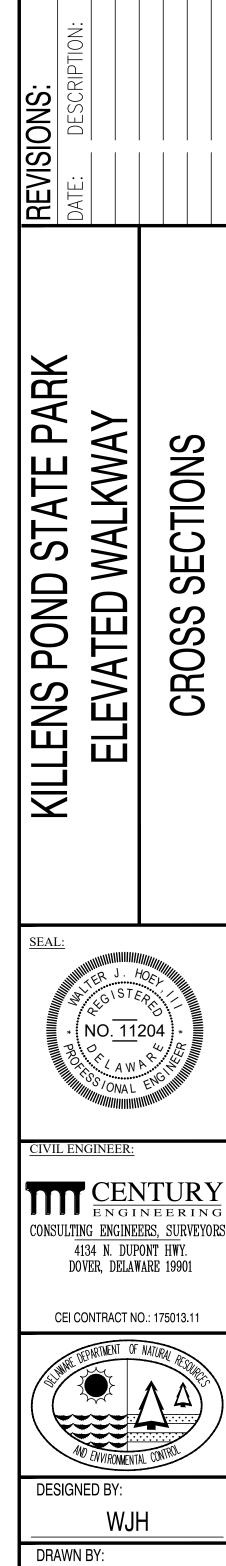

JSW

AUGUST 2020

1"=10'

2020-KP-100


CHECKED BY:

SCALE:

SHEET NO.:

CONTRACT NO.:

CROSS SECTIONS

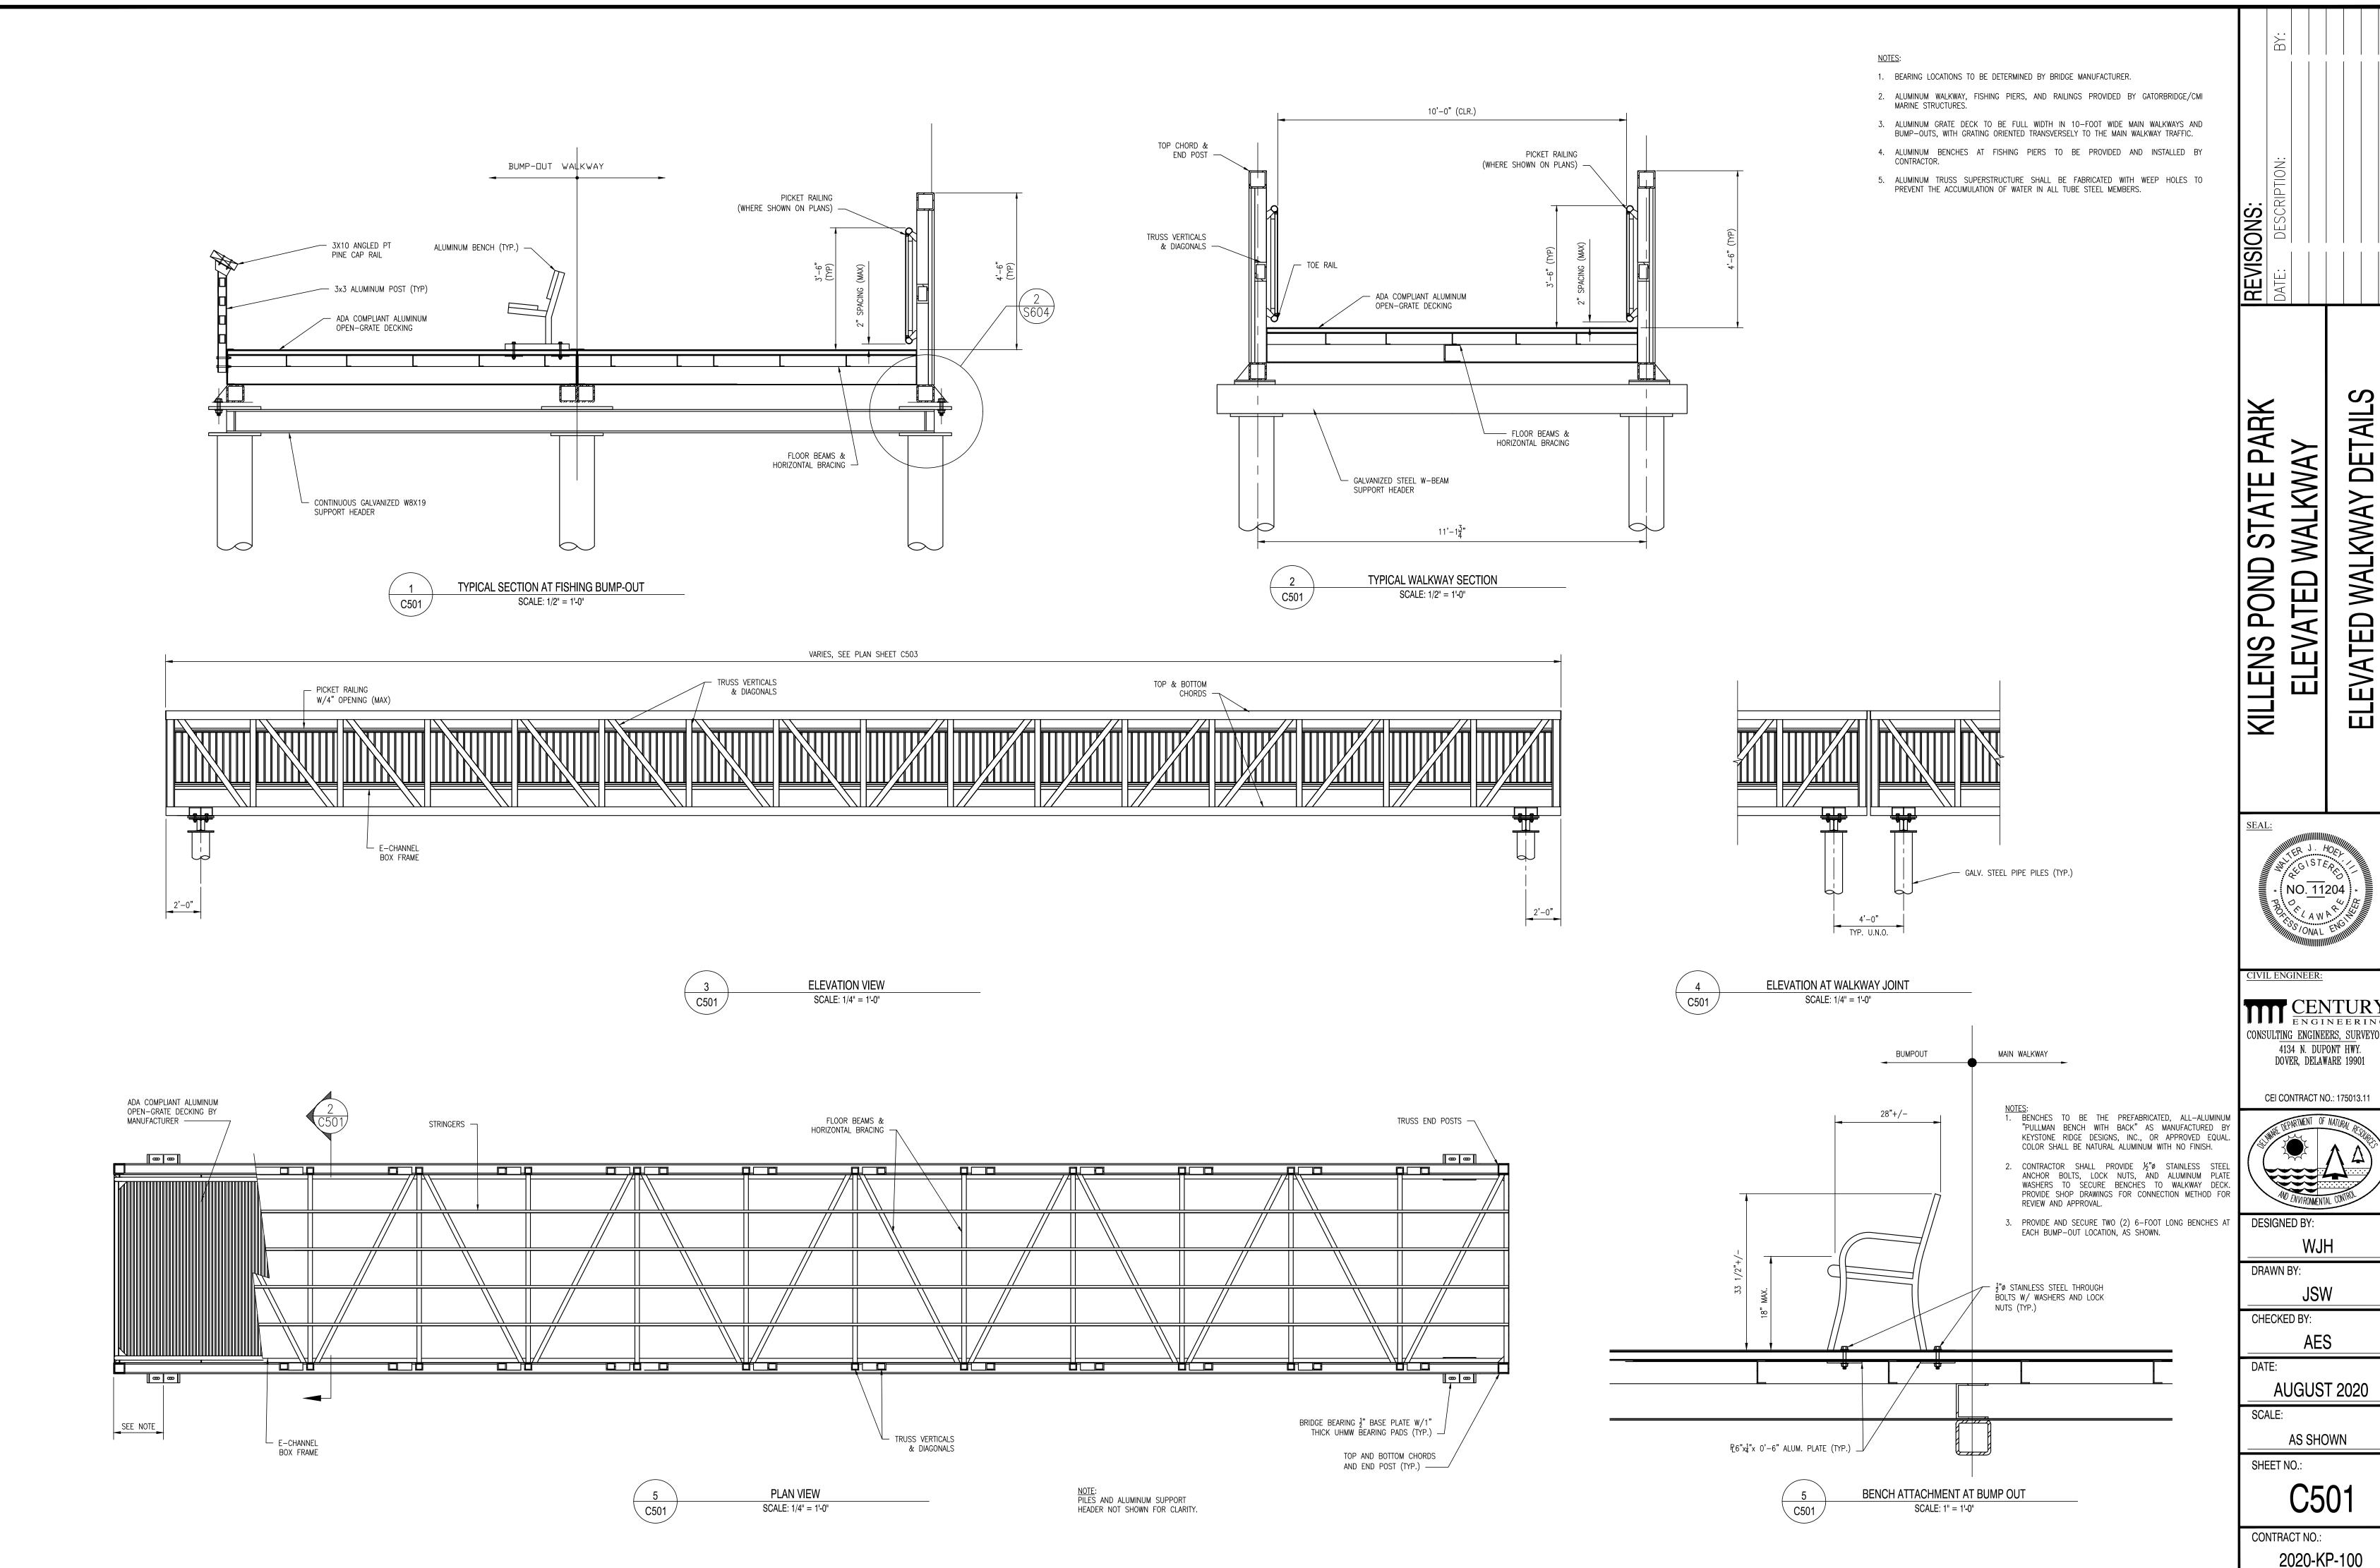

DET/


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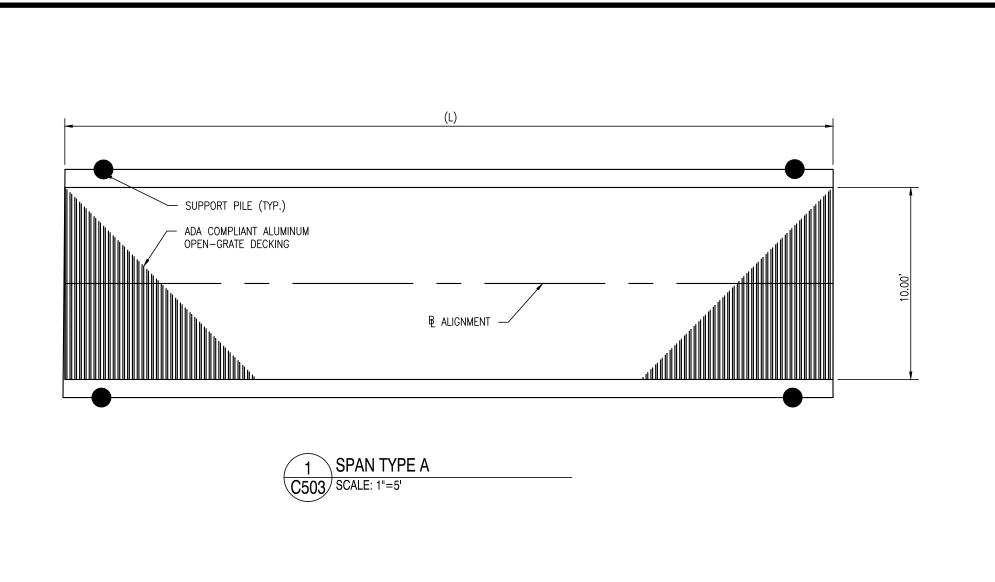
CENTURY ENGINEERING CONSULTING ENGINEERS, SURVEYORS


CEI CONTRACT NO.: 175013.11




2020-KP-100



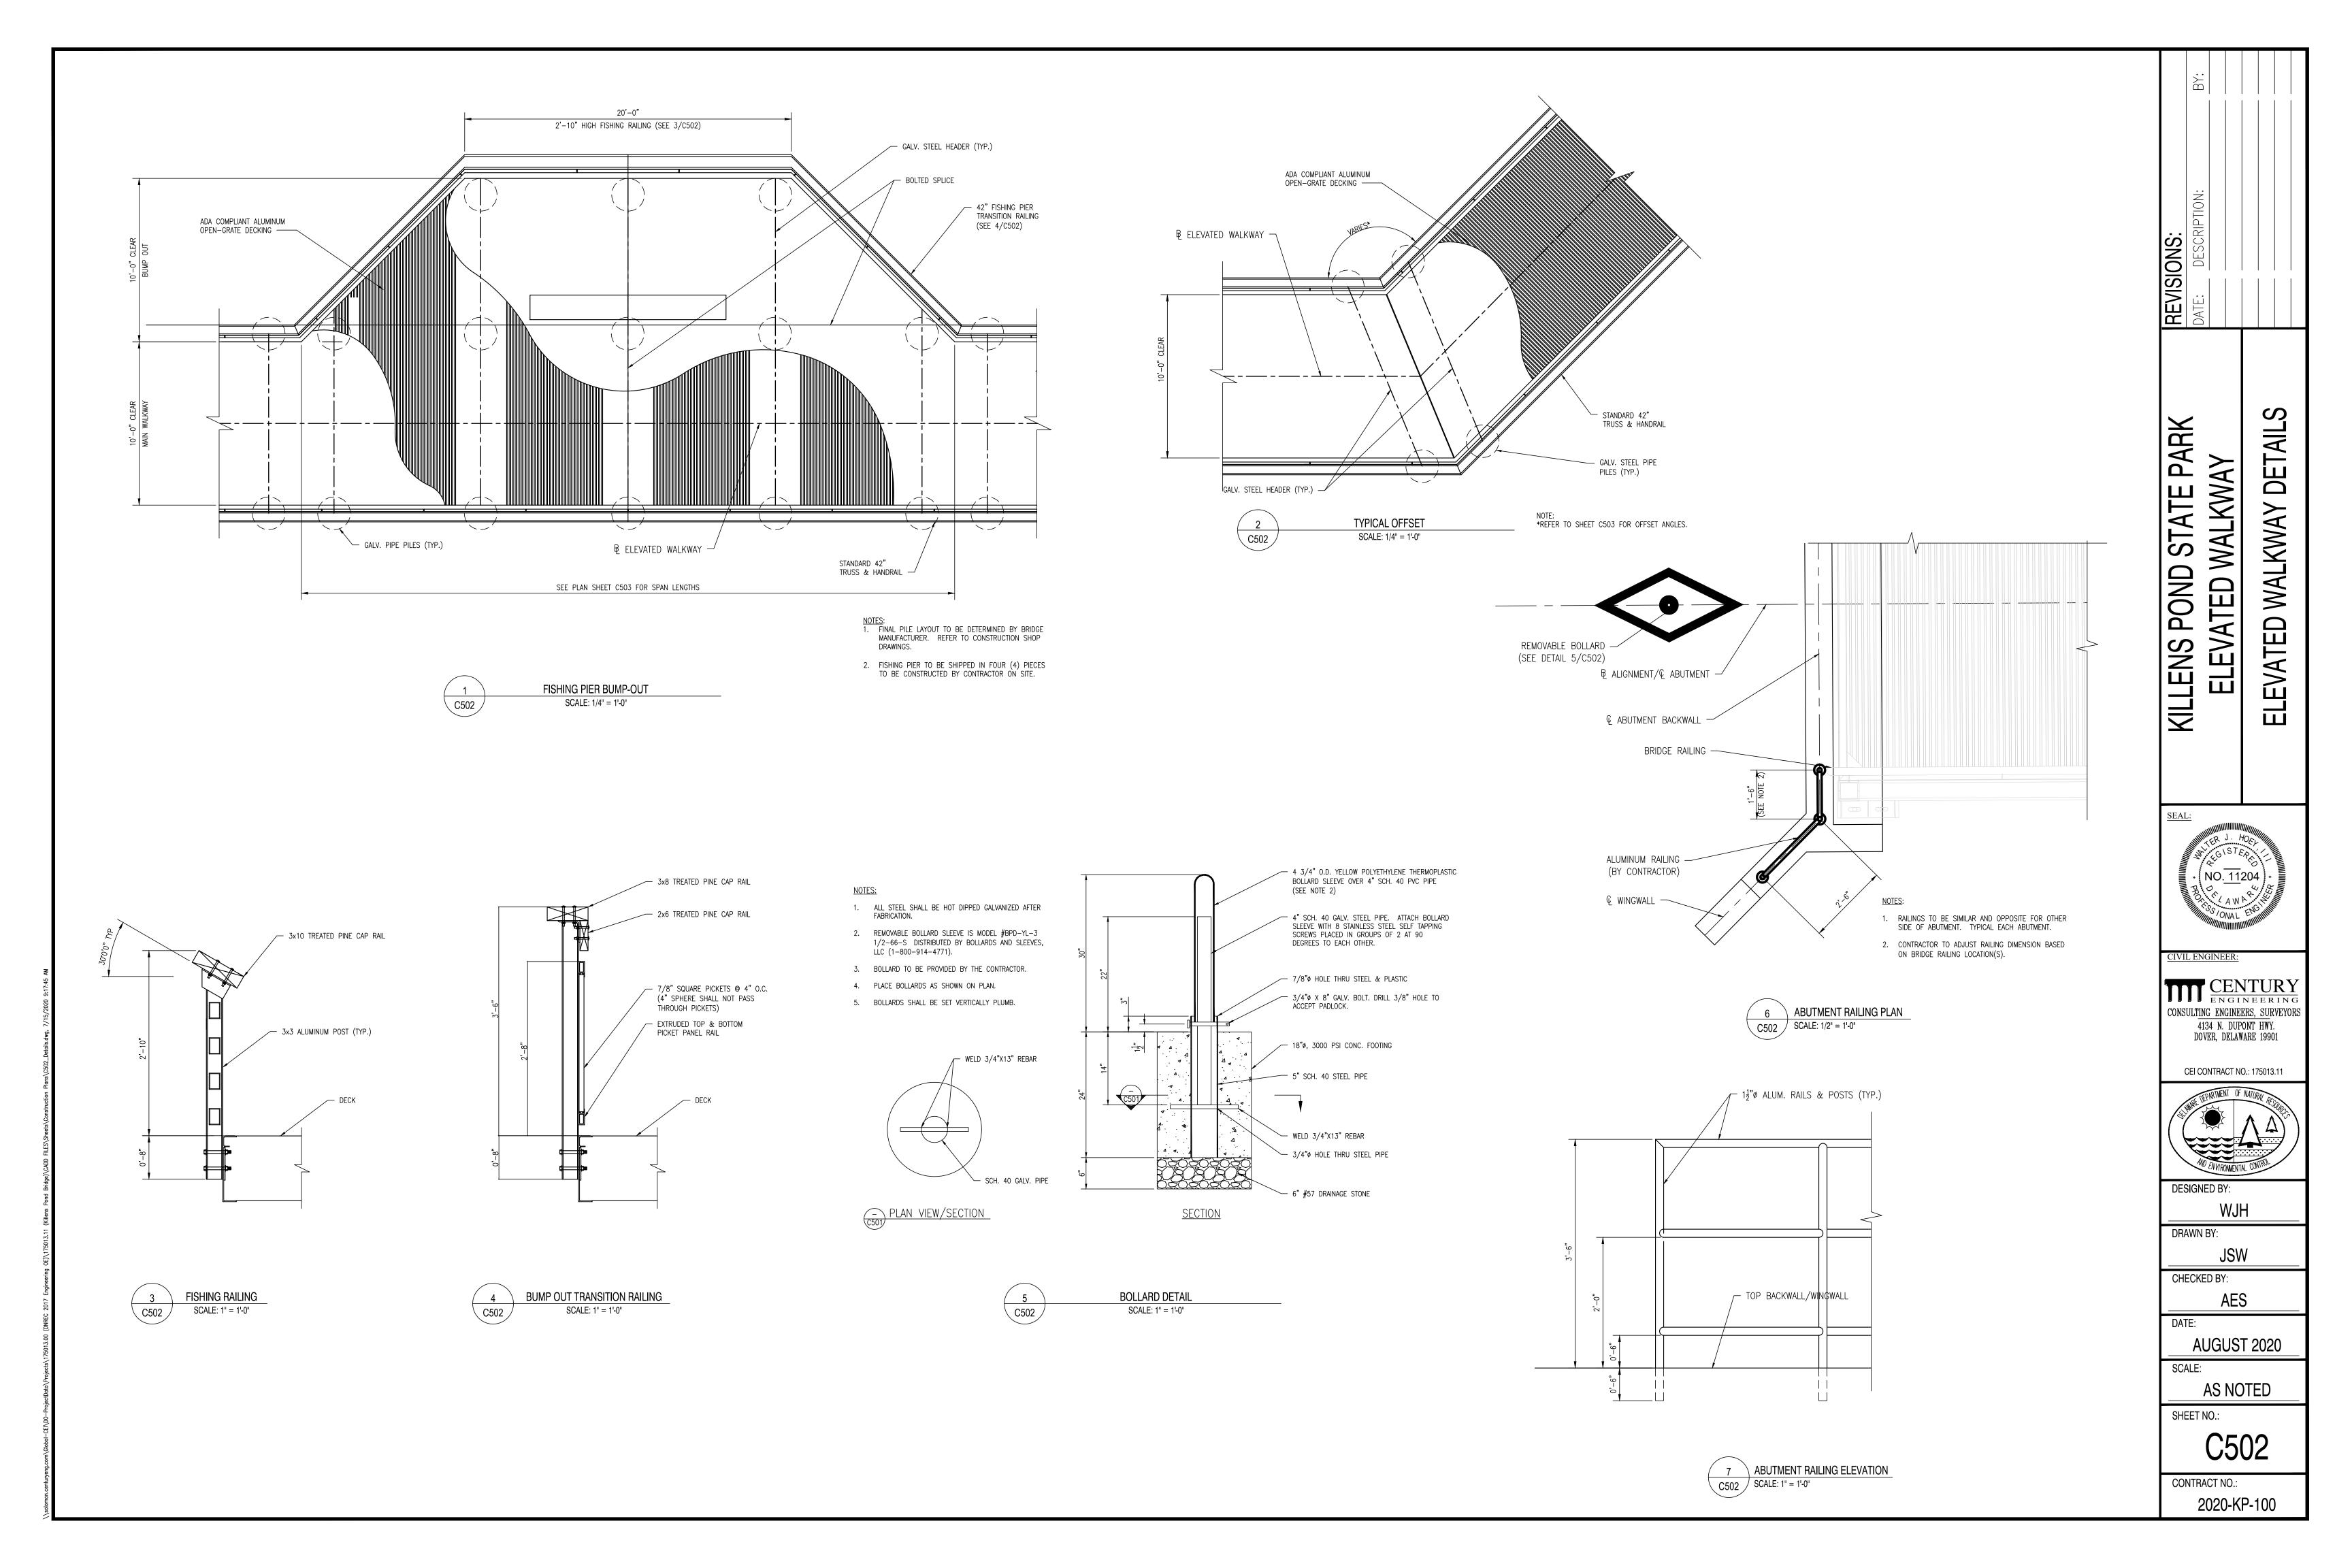


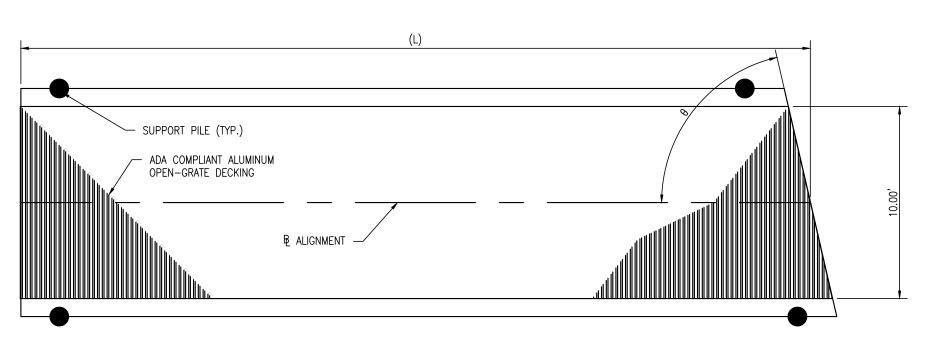

SPAN TYPE B
C503 SCALE: 1"=5"

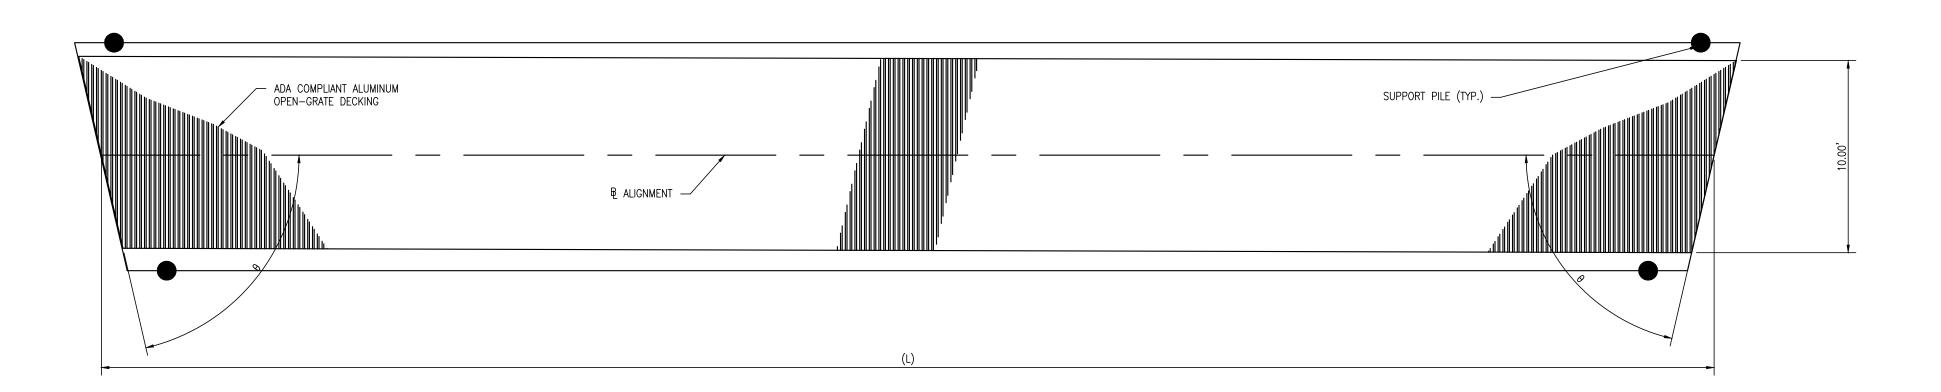

3 SPAN TYPE C C503 SCALE: 1"=5'

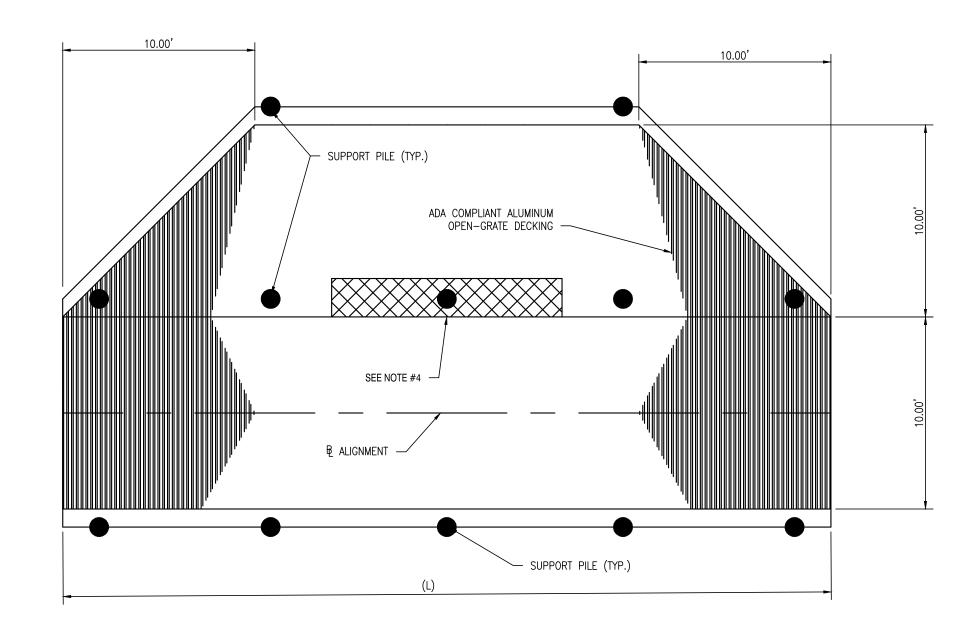

SPAN TYPE D

SCALE: 1"=5"

	WALKWAY SP	AN SCHEDULE	
SPAN	TYPE	LENGTH (L)	ANGLE (θ)
1	A	31.49' 33.00'	
2	A	40'	
3	В	41.13'	77°00'00"
4	B (* SEE NOTE 1)	40.24'	77°00'00"
5	D	39.21' 40.38'	77°00'00"
6	С	84.00'	77°00'00"/77°00'00'
7	B (* SEE NOTE 1)	42.35'	77°00'00"
8	В	41.88'	77°15'00"
9	B (* SEE NOTE 1)	39.42'	77°15'00"
10	D	40.00'	
11	A	40.00'	
12	A	40.00'	
13	D	40.00'	
14	A	40.00'	
15	A	40.00'	
16	D	40.00'	
17	A	40.00'	
18	A	40.00'	
19	A	40.00'	
20	A	48.38' 49.88'	

- NOTES: 1. * SPAN ROTATED 180° FROM VIEW.
 - 2. SPAN A AND D HAVE 90° SECTIONS.
 - 3. RAILING NOT SHOWN FOR CLARITY.
 - 4. INSTALL (2) 6' LONG BY 2' WIDE ALUMINUM BENCHES, SEE DETAIL 6/C501.
 - 10.00 FEET REPRESENTS THE CLEAR WIDTH ON EACH SPAN. REFER TO SHEET C501 FOR FULL DIMENSIONS.

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DETAILS

WALKWAY

REVISIONS:


DATE: DESCRI

ELEVATED KILLENS F ELEVA

CIVIL ENGINEER:

CENTURY ENGINEERING CONSULTING ENGINEERS, SURVEYORS 4134 N. DUPONT HWY. DOVER, DELAWARE 19901

CEI CONTRACT NO.: 175013.11

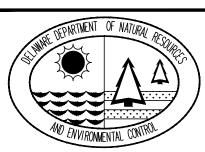

DESIGNED BY:

DRAWN BY:

JSW


CHECKED BY: AES

AUGUST 2020

SCALE: AS SHOWN

SHEET NO.:

CONTRACT NO.: 2020-KP-100

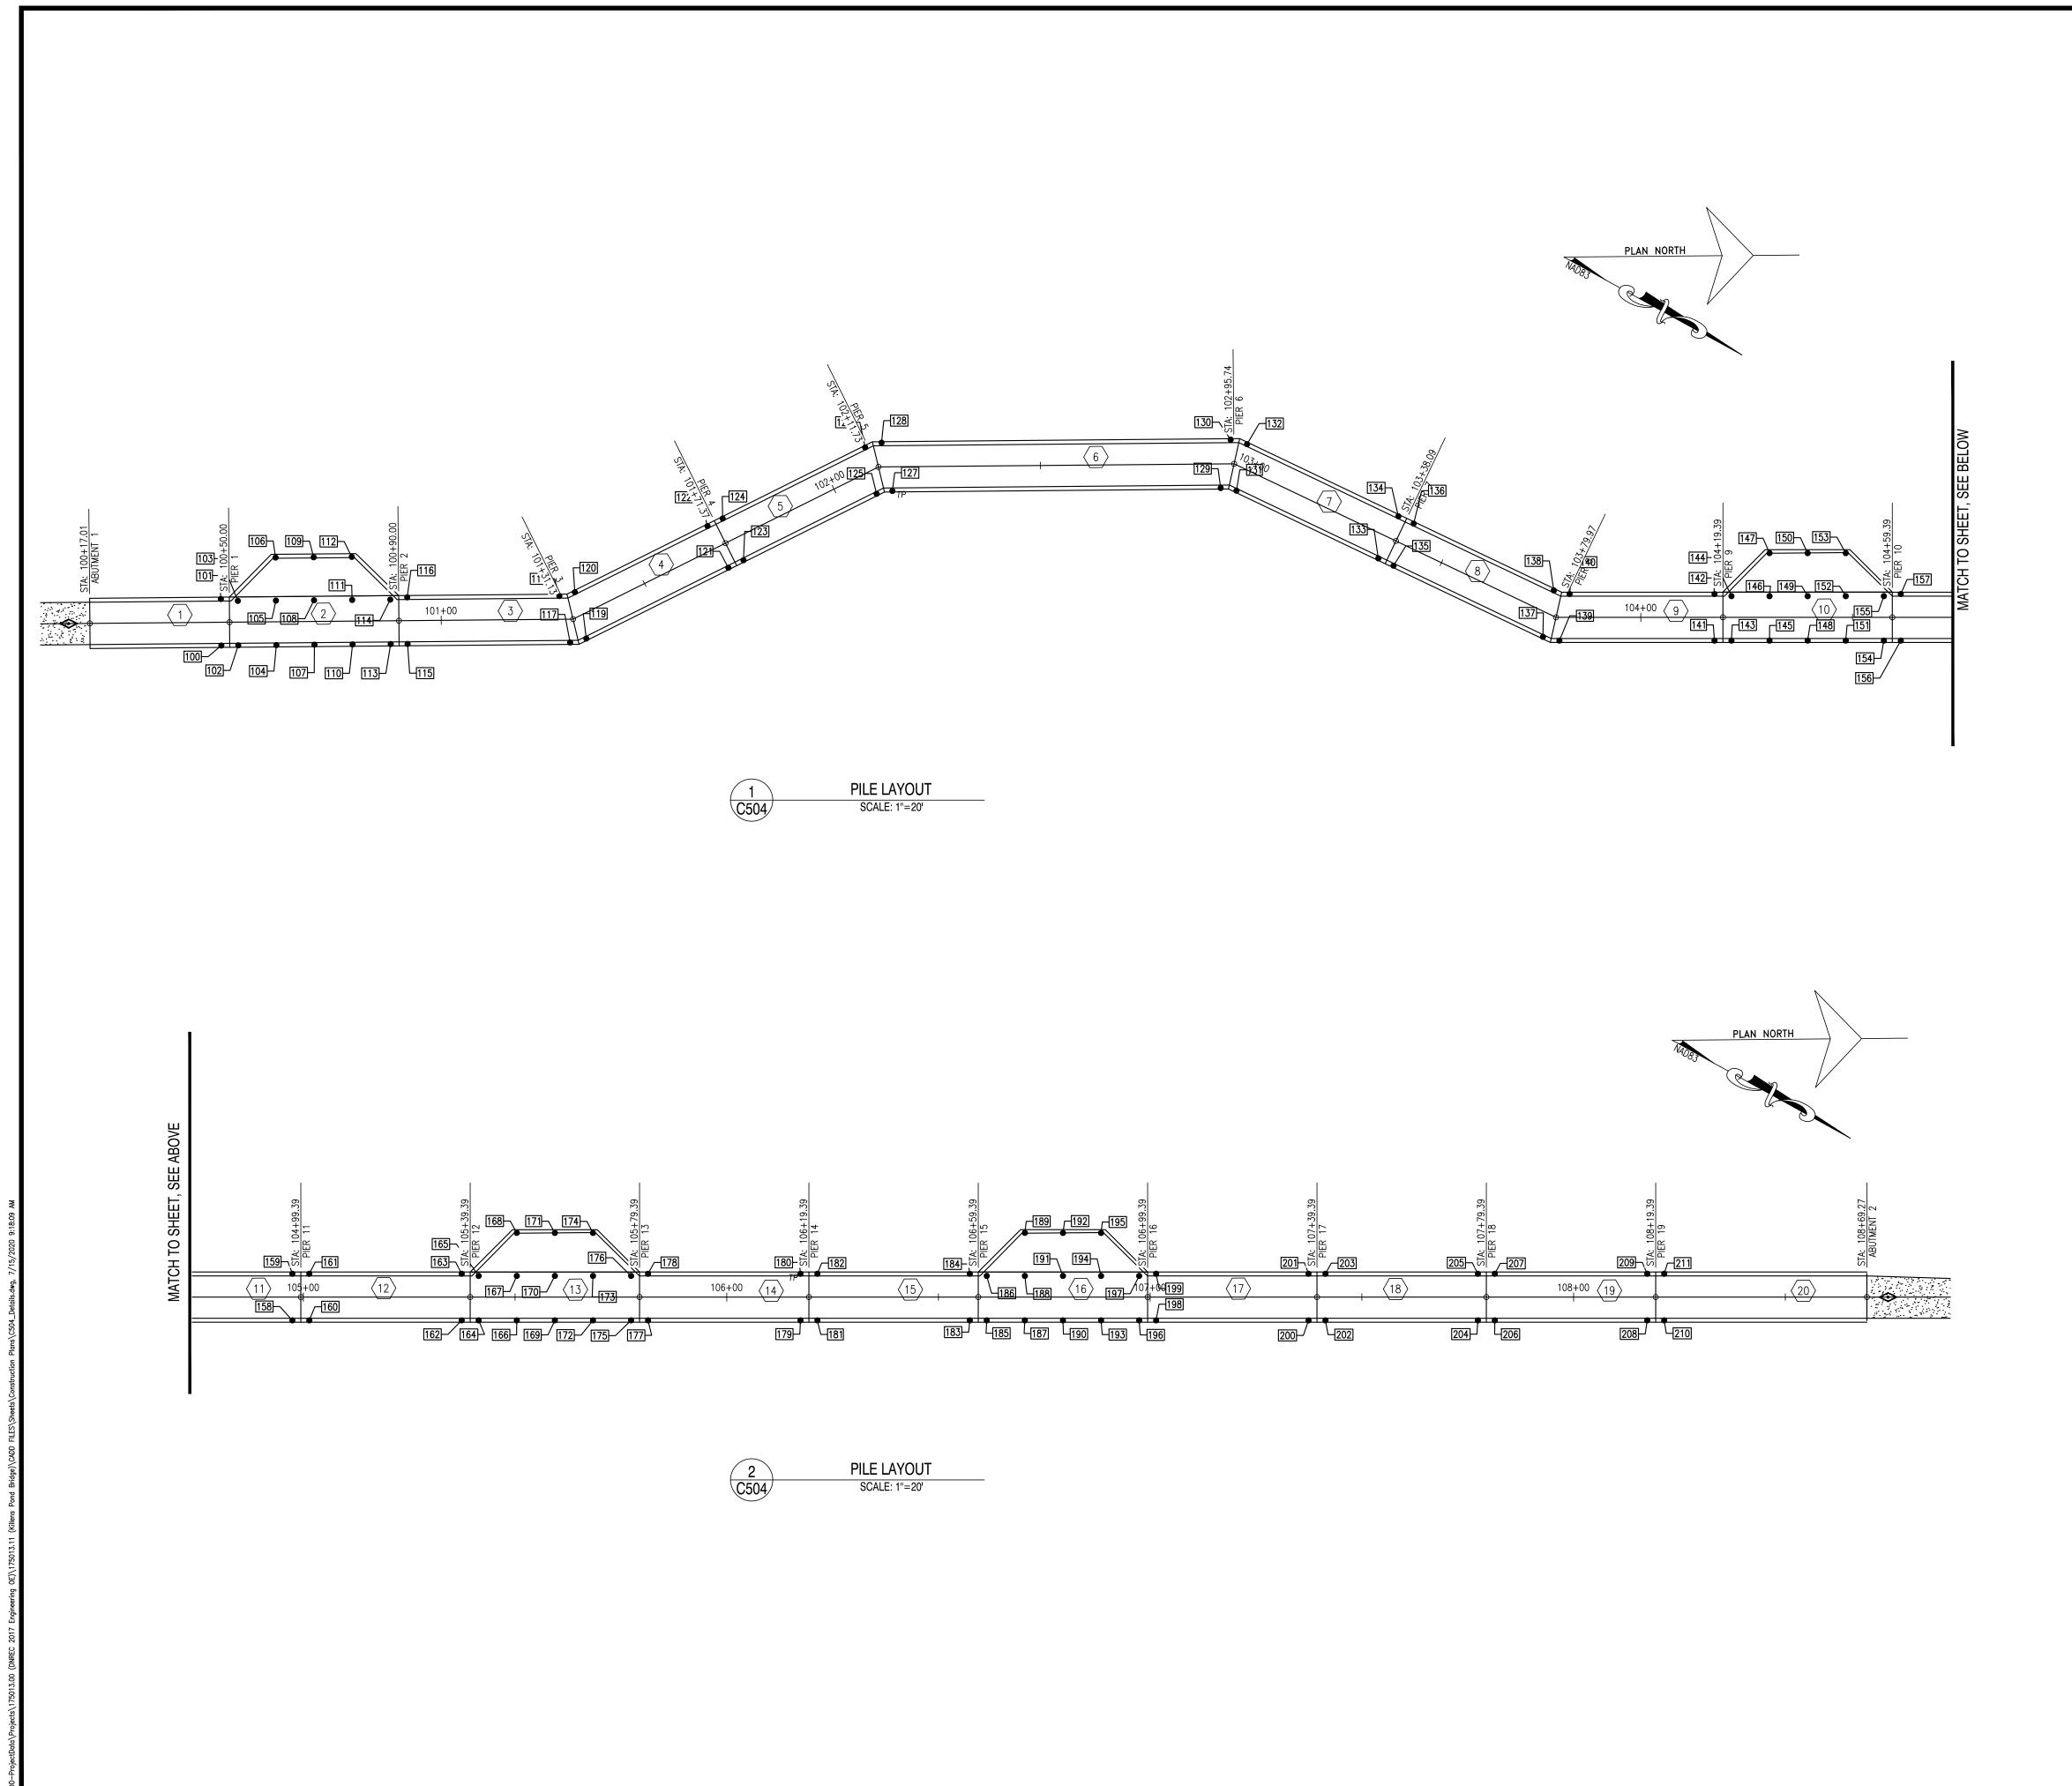

POINT NO.	DESCRIPTION	NORTHING	EASTING
100	PILES	357243.9395	624150.0003
101	PILES	357238.5543	624140.4131
102	PILES	357247.4272	624148.0417
103	PILES	357242.2859	624138.8866
104	PILES	357255.2753	624143.6364
105	PILES	357250.1340	624134.4812
106	PILES	357245.1608	624125.6216
107	PILES	357263.1234	624139.2310
108	PILES	357257.9821	624130.0759
109	PILES	357253.0089	624121.2162
110	PILES	357270.9715	624134.8256
111	PILES	357265.8302	624125.6705
112	PILES	357260.8570	624116.8109
113	PILES	357278.8201	624130.4211
114	PILES	357273.6788	624121.2660
115	PILES	357282.3051	624128.4578
116	PILES	357276.9190	624118.8667
117	PILES	357315.7831	624109.6572
118	PILES	357308.2490	624101.2724
119	PILES	357318.6842	624107.0070
120	PILES	357311.0435	624098.7176
121	PILES	357340.0108	624076.1871
122	PILES	357330.9652	624069.9278
123	PILES	357342.2869	624072.8978
124	PILES	357333.2413	624066.6386
125	PILES	357362.2768	624044.0095
126	PILES	357354.6331	624035.7244
127	PILES	357365.2094	624041.6129
128	PILES	357357.4712	624032.8647
129	PILES	357432.8148	624003.6469
130	PILES	357429.3726	623992.4862
131	PILES	357436.3824	624002.3906
132	PILES	357433.2864	623991.5516
133	PILES		
		357473.4400	624000.2423
134	PILES	357472.8034	623989.2608
135	PILES	357477.4333	624000.0108
136	PILES	357476.7967	623989.0293
137	PILES	357516.4563	623997.7487
138	PILES	357513.4071	623986.9070
139	PILES	357520.2779	623996.6466
140	PILES	357517.0885	623985.8464
141	PILES	357552.3673	623978.9927
142	PILES	357547.0651	623969.3549
143	PILES	357555.8707	623977.0624
144	PILES	357550.8095	623967.8627
145	PILES	357563.7570	623972.7258
146	PILES	357558.6958	623963.5261
147	PILES	357553.8002	623954.6234
148	PILES	357571.6433	623968.3892
149	PILES	357566.5821	623959.1895
150	PILES	357561.6865	623950.2867
151	PILES	357579.5296	623964.0525
152	PILES	357574.4684	623954.8528
153	PILES	357569.5728	623945.9501
154	PILES	357587.4163	623959.7167
155	PILES	357582.3552	623950.5170
156	PILES	357590.9184	623957.7836

PILE POINT LAYOUT

1588 PILES 3576224601 623940.4 1599 PILES 357622.4601 623930.7 1599 PILES 357625.9647 623930.7 1599 PILES 357625.9647 623930.7 1590 PILES 357625.9662 623928.8 161 PILES 357620.6625 623928.8 162 PILES 357652.0662 623928.8 163 PILES 35765.9663 623921.1 11406 624134.4812 6163 PILES 35765.9487 623910.1 1680 624150.6216 6164 PILES 35766.3506 62391.8 1690 PILES 35766.3850 62390.6 1690 PILES 35766.8350 62390.6 1690 PILES 35766.8350 62390.6 1690 PILES 35766.8350 62390.6 1690 PILES 35766.8258 62390.6 1690 PILES 35766.8258 62390.6 1690 PILES 35766.8258 62390.6 1701 PILES 35766.8258 62390.6 1702 PILES 35766.8258 62390.6 1703 PILES 35766.8258 62390.6 1704 PILES 35766.8258 62390.6 1705 PILES 35766.8258 62390.6 1707 PILES 35766.8258 62390.6 1708 PILES 35768.9478 62390.6 1709 PILES 35776.056 62380.8 1709 PILES 35776.056 62380.8 1800 PILES 35776.056 62380	701			FILL FO	JINI LATOUT	
1594 1596	HING	EASTING	157	PILES	357585.6161	623948.14
160	3.9395	624150.0003	158	PILES	357622.4601	623940.43
2.2869 £24138.8866 161 PILES 357620.6625 £23928.8 2.2753 £24143.6364 162 PILES 357657.5065 £23921.1 1.1540 £2413.43612 163 PILES 357657.5065 £23921.1 1.163 PILES 357661.0100 £23919.2 £2341.2 £2391.2 £2341.2 £2391.8 £2391.8 1.0089 £2412.2162 166 PILES 357668.8362 £2394.8 £2391.8 1.830 £2412.6705 168 PILES 357668.3390 £2396.2 1.850 £2412.6705 169 PILES 357676.7225 £23901.5 1.850 £2412.65705 169 PILES 357676.7225 £23901.3 1.820 £2412.660 172 PILES 357676.7215 £23901.3 1.930 £24128.4578 173 PILES 357692.5557 £23901.3 1.931 £24109.6721 175 PILES 357692.5557 £23901.3 1.932 £24088.7176 176<	3.5543	624140.4131	159	PILES	357617.1578	623930.79
162 PILES 357667.5065 623921.1 1.1340 624134.4812 163 PILES 357652.2042 623911.5 1.1608 624125.6216 164 PILES 357661.0100 623919.2 1.1234 624130.2310 165 PILES 357668.8962 623914.8 1.0089 624121.2162 167 PILES 357668.8962 623914.8 1.0089 624121.2620 167 PILES 357668.8962 623914.8 1.0091 624134.8256 168 PILES 357668.8962 623914.8 1.0091 624134.8256 168 PILES 357668.8962 623914.8 1.0091 624136.605 169 PILES 357668.6258 62390.2 1.0091 62412.6606 170 PILES 357668.6258 62390.2 1.0091 62410.4211 171 PILES 357669.6078 62390.2 1.0091 62410.8667 174 PILES 357674.7121 623981.8 1.0091 62410.6572 175 PILES 357674.7121 623981.8 1.0091 62410.6572 175 PILES 357690.675 62390.2 1.0093 62408.7176 178 PILES 357690.575 62390.3 1.0093 62408.7176 178 PILES 357761.038 62382.5 1.0094 62404.0095 183 PILES 357761.038 62380.6 1.0094 62404.0095 183 PILES 357761.081 623871.0 1.0094 62404.6129 186 PILES 357761.081 623851.0 1.0094 62404.6129 186 PILES 357761.081 623851.0 1.0094 62404.6129 186 PILES 357761.081 623851.0 1.0094 62404.6129 186 PILES 357761.081 623852.7 1.0094 62400.2423 191 PILES 357761.080 623852.8 1.0096 623992.093 194 PILES 357761.080 623834.8 1.0096 623992.093 194 PILES 35779.830 623384.8 1.0096	7.4272	624148.0417	160	PILES	357625.9647	623938.50
163 PILES 357662.2042 623911.5 168	2.2859	624138.8866	161	PILES	357620.6625	623928.86
164	5.2753	624143.6364	162	PILES	357657.5065	623921.14
1.02.43 624139.2310).1340	624134.4812	163	PILES	357652.2042	623911.51
166	5.1608	624125.6216	164	PILES	357661.0100	623919.21
.0088 624121.2162 167 PILES 357663.8350 623905.6 .9715 624134.8256 168 PILES 357658.9395 623896.7 .8302 624125.6705 169 PILES 357676.7825 623910.5 .8370 624116.8109 170 PILES 357666.8258 623892.4 .8201 62412.2660 172 PILES 357684.6990 623906.2 .3051 624128.6578 173 PILES 357696.0576 623897.0 .9190 624118.8667 174 PILES 357674.7121 623885.1 .7831 624109.6572 1775 PILES 357696.0575 623901.8 .2490 624107.0070 177 PILES 357696.0575 623890.8 .0435 624068.9278 180 PILES 357722.5969 623872.9 .2266 624072.8978 180 PILES 357722.5969 623672.9 .22768 62404.0095 183 PILES 357762.6456 623863.3 .6331 62406.6386 182 PILES 357766.1490 623861.3 .22768 62404.0095 183 PILES 357761.0881 623852.1 .6331 62403.57244 184 PILES 357761.0881 623852.1 .23824 62404.3095 183 PILES 357761.0881 623852.1 .8148 624003.6469 187 PILES 357761.0881 623852.1 .3726 623992.4862 188 PILES 357761.0881 623852.1 .4000 62400.0108 190 PILES 357774.0355 623852.7 .4071 623886.9070 190 PILES 357784.7470 623852.7 <t< td=""><td>5.1234</td><td>624139.2310</td><td>165</td><td>PILES</td><td>357655.9487</td><td>623910.01</td></t<>	5.1234	624139.2310	165	PILES	357655.9487	623910.01
168	7.9821	624130.0759	166	PILES	357668.8962	623914.88
.8302 624125.6705 169 PILES 357676.7825 623910.5 .8570 624116.8109 170 PILES 357676.7825 623901.5 .8201 624130.4211 171 PILES 357666.8256 623892.4 .8301 624128.4578 173 PILES 357684.6690 623960.2 .8310 624107.6772 175 PILES 35769.6076 623897.0 .8642 624107.0070 177 PILES 35769.60575 623899.9 .0435 624096.7176 178 PILES 35769.07554 623890.3 .0562 624072.8978 180 PILES 357727.5992 623862.5 .0783 624040.095 181 PILES 357722.6966 623872.0 .0833 624044.0095 183 PILES 357766.1490 623863.3 .0844 624035.7244 184 PILES 357761.0881 623867.0 .0852 623992.4862 188 PILES 357766.1490 623863.3 <t< td=""><td>3.0089</td><td>624121.2162</td><td>167</td><td>PILES</td><td>357663.8350</td><td>623905.68</td></t<>	3.0089	624121.2162	167	PILES	357663.8350	623905.68
.8576 624116.8109 170 PILES 357671.7215 623901.3 .8201 624130.4211 171 PILES 357666.8256 62392.4 .6788 624121.2660 172 PILES 357684.6690 623906.2 .39190 62418.8667 174 PILES 357674.7121 623888.1 .6842 624107.0070 177 PILES 35769.60575 623892.6 .6842 624076.1871 178 PILES 35769.0575 623899.9 .0008 624072.8978 180 PILES 357727.5992 623862.5 .2868 624072.8978 181 PILES 357722.2969 623872.9 .2878 62404.0095 183 PILES 357762.6456 623863.3 .2878 62404.0095 183 PILES 357761.0881 623867.0 .3726 623992.4862 184 PILES 357761.0881 623863.3 .3804 624002.3906 189 PILES 357776.0906 623867.0).9715	624134.8256	168	PILES	357658.9395	623896.78
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3.4071 623986.9070 196 PILES 357797.6920 623844.0 3.2779 623996.6466 197 PILES 357792.6338 623834.8 3.0885 623985.8464 198 PILES 357801.1966 623842.0 3.3673 623978.9927 199 PILES 357795.8946 623832.4 3.0651 623969.3549 200 PILES 357832.7383 623824.7 3.8707 623977.0624 201 PILES 357827.4360 623815.1 3.8095 623967.8627 202 PILES 357836.2430 623822.8 3.7570 623972.7258 203 PILES 357867.7847 623805.4 3.8002 623953.5261 204 PILES 357862.4824 623805.4 3.8002 623954.6234 205 PILES 357862.4824 623795.8 3.5821 623959.1895 207 PILES 357865.9871 623793.8 3.6865 623950.2867 208 PILES 357897.5288 623776.5 3.596 623964.0525 209 PILES 3578906.3357	5.7967	623989.0293	194	PILES	357784.7470	623839.16
1.2779 623996.6466 197 PILES 357792.6338 623834.8 1.0885 623985.8464 198 PILES 357801.1966 623842.0 1.3673 623978.9927 199 PILES 357795.8946 623832.4 2.0651 623969.3549 200 PILES 357832.7383 623824.7 1.8707 623977.0624 201 PILES 357827.4360 623815.1 1.8095 623967.8627 202 PILES 357836.2430 623822.8 1.7570 623972.7258 203 PILES 357867.7847 623805.4 1.8002 623954.6234 204 PILES 357862.4824 623805.4 1.8002 623954.6234 205 PILES 357862.4824 623795.8 1.6433 623959.1895 206 PILES 357865.9871 623793.8 1.6865 623950.2867 208 PILES 3578902.8311 623786.1 1.5296 623964.0525 209 PILES 357897.5288 623776.5 1.4684 6239545.9501 211 PILES 357901.0334	5.4563	623997.7487	195	PILES	357779.8511	623830.26
1.0885 623985.8464 198 PILES 357801.1966 623842.0 1.3673 623978.9927 199 PILES 357795.8946 623832.4 2.0651 623969.3549 200 PILES 357832.7383 623824.7 1.8707 623977.0624 201 PILES 357827.4360 623815.1 1.8095 623967.8627 202 PILES 357836.2430 623822.8 1.7570 623972.7258 203 PILES 357867.7847 623813.1 1.8002 623954.6234 204 PILES 357862.4824 623795.8 1.8002 623954.6234 205 PILES 357862.4824 623795.8 1.6433 623968.3892 206 PILES 357865.9871 623793.8 1.6865 623959.1895 207 PILES 357865.9871 623793.8 1.5296 623964.0525 209 PILES 357897.5288 623776.5 1.4684 623954.8528 210 PILES 357906.3357 623784.2 1.5728 623945.9501 211 PILES 357901.0334	3.4071	623986.9070	196	PILES	357797.6920	623844.02
.3673 623978.9927 199 PILES 357795.8946 623832.4 7.0651 623969.3549 200 PILES 357832.7383 623824.7 8.8707 623977.0624 201 PILES 357827.4360 623815.1 8.8095 623967.8627 202 PILES 357836.2430 623822.8 8.7570 623972.7258 203 PILES 357867.7847 623805.4 8.6958 623963.5261 204 PILES 357867.7847 623805.4 8.8002 623954.6234 205 PILES 357862.4824 623795.8 8.6433 623968.3892 206 PILES 357865.9871 623793.8 8.5821 623959.1895 207 PILES 357865.9871 623793.8 8.6865 623950.2867 208 PILES 357897.5288 623776.5 8.4684 623954.8528 210 PILES 357906.3357 623784.2 8.5728 623945.9501 211 PILES 357901.0334 623774.6).2779	623996.6466	197	PILES	357792.6338	623834.83
2.0651 623969.3549 200 PILES 357832.7383 623824.7 2.8707 623977.0624 201 PILES 357827.4360 623815.1 2.8095 623967.8627 202 PILES 357836.2430 623822.8 2.7570 623972.7258 203 PILES 357830.9407 623813.1 3.6958 623963.5261 204 PILES 357867.7847 623805.4 3.8002 623954.6234 205 PILES 357862.4824 623795.8 3.5821 623968.3892 206 PILES 357865.9871 623793.8 3.5821 623959.1895 207 PILES 357865.9871 623793.8 3.5296 623964.0525 208 PILES 357897.5288 623776.5 3.4684 623954.8528 210 PILES 357906.3357 623784.2 3.5728 623945.9501 211 PILES 357901.0334 623774.6	7.0885	623985.8464	198	PILES	357801.1966	623842.09
.8707 623977.0624 201 PILES 357827.4360 623815.11 .8095 623967.8627 202 PILES 357836.2430 623822.8 .7570 623972.7258 203 PILES 357830.9407 623813.1 .6958 623963.5261 204 PILES 357867.7847 623805.4 .8002 623954.6234 205 PILES 357862.4824 623795.8 .6433 623968.3892 206 PILES 357871.2893 623803.5 .5821 623959.1895 207 PILES 357865.9871 623793.8 .6865 623950.2867 208 PILES 357902.8311 623786.1 .5296 623964.0525 209 PILES 357897.5288 623776.5 .4684 623954.8528 210 PILES 357906.3357 623784.2 .5728 623945.9501 211 PILES 357901.0334 623774.6	2.3673	623978.9927	199	PILES	357795.8946	623832.46
202 PILES 357836.2430 623822.8 27570 623972.7258 203 PILES 357830.9407 623813.1 26958 623963.5261 204 PILES 357867.7847 623805.4 28002 623954.6234 205 PILES 357862.4824 623795.8 36433 623968.3892 206 PILES 357871.2893 623803.5 35821 623959.1895 207 PILES 357865.9871 623793.8 35865 623950.2867 208 PILES 357902.8311 623786.1 35296 623964.0525 209 PILES 357897.5288 623776.5 35728 623945.9501 211 PILES 357901.0334 623774.6	7.0651	623969.3549	200	PILES	357832.7383	623824.74
.7570 623972.7258 203 PILES 357830.9407 623813.1 .6958 623963.5261 204 PILES 357867.7847 623805.4 .8002 623954.6234 205 PILES 357862.4824 623795.8 .6433 623968.3892 206 PILES 357871.2893 623803.5 .5821 623959.1895 207 PILES 357865.9871 623793.8 .6865 623950.2867 208 PILES 357902.8311 623786.1 .5296 623964.0525 209 PILES 357897.5288 623776.5 .4684 623954.8528 210 PILES 357906.3357 623784.2 .5728 623945.9501 211 PILES 357901.0334 623774.6	5.8707	623977.0624	201	PILES	357827.4360	623815.10
.6958 623963.5261 204 PILES 357867.7847 623805.4 .8002 623954.6234 205 PILES 357862.4824 623795.8 .6433 623968.3892 206 PILES 357871.2893 623803.5 .5821 623959.1895 207 PILES 357865.9871 623793.8 .6865 623950.2867 208 PILES 357902.8311 623786.1 .5296 623964.0525 209 PILES 357897.5288 623776.5 .4684 623954.8528 210 PILES 357906.3357 623784.2 .5728 623945.9501 211 PILES 357901.0334 623774.6	.8095	623967.8627	202	PILES	357836.2430	623822.81
.8002 623954.6234 205 PILES 357862.4824 623795.8 .6433 623968.3892 206 PILES 357871.2893 623803.5 5.5821 623959.1895 207 PILES 357865.9871 623793.8 .6865 623950.2867 208 PILES 357902.8311 623786.1 .5296 623964.0525 209 PILES 357897.5288 623776.5 .4684 623954.8528 210 PILES 357906.3357 623784.2 .5728 623945.9501 211 PILES 357901.0334 623774.6	3.7570	623972.7258	203	PILES	357830.9407	623813.17
.6433 623968.3892 206 PILES 357871.2893 623803.5 6.5821 623959.1895 207 PILES 357865.9871 623793.8 .6865 623950.2867 208 PILES 357902.8311 623786.1 .5296 623964.0525 209 PILES 357897.5288 623776.5 .4684 623954.8528 210 PILES 357906.3357 623784.2 .5728 623945.9501 211 PILES 357901.0334 623774.6	3.6958	623963.5261	204	PILES	357867.7847	623805.46
3.5821 623959.1895 207 PILES 357865.9871 623793.8 3.6865 623950.2867 208 PILES 357902.8311 623786.1 3.5296 623964.0525 209 PILES 357897.5288 623776.5 3.4684 623954.8528 210 PILES 357906.3357 623784.2 3.5728 623945.9501 211 PILES 357901.0334 623774.6	3.8002	623954.6234	205	PILES	357862.4824	623795.82
.6865 623950.2867 208 PILES 357902.8311 623786.1 .5296 623964.0525 209 PILES 357897.5288 623776.5 .4684 623954.8528 210 PILES 357906.3357 623784.2 .5728 623945.9501 211 PILES 357901.0334 623774.6	.6433	623968.3892	206	PILES	357871.2893	623803.53
.5296 623964.0525 209 PILES 357897.5288 623776.5 .4684 623954.8528 210 PILES 357906.3357 623784.2 .5728 623945.9501 211 PILES 357901.0334 623774.6	5.5821	623959.1895	207	PILES	357865.9871	623793.89
.4684 623954.8528 210 PILES 357906.3357 623784.2 .5728 623945.9501 211 PILES 357901.0334 623774.6	.6865	623950.2867	208	PILES	357902.8311	623786.18
.4684 623954.8528 210 PILES 357906.3357 623784.2 .5728 623945.9501 211 PILES 357901.0334 623774.6	0.5296					623776.54
.5728 623945.9501 211 PILES 357901.0334 623774.6	.4684	623954.8528	210			623784.25
	.5728					623774.61
/ 0200001/10/ 1	7.4163	623959.7167			<u> </u>	L

NOTES:

1. PILE TIP ELEVATIONS PROVIDED ARE MINIMUM AND FOR ESTIMATING PURPOSES ONLY. ACTUAL PILE LENGTHS MAY BE LONGER AND SHALL BE ESTABLISHED FOLLOWING INSTALLATION OF TEST PILES UTILIZING A DYNAMIC LOAD TEST CONFORMING TO ASTM D4549 — STANDARD TEST METHOD FOR HIGH—STRAIN DYNAMIC TESTING OF PILES.

- 2. Φ_{TP} Indicates test pile location.
- 3. INDICATES PRODUCTION PILE LOCATION.
- 4. REFER TO SHEETS C401 AND C402 FOR ADDITIONAL INFORMATION.
- 5. ALL PILES SHALL BE 12"Ø GALVANIZED SCHEDULE 80 PIPE PILES <u>WITH THE EXCEPTION OF PILES SUPPORTING SPAN #6, WHICH SHALL BE 14"Ø X 0.625" GALVANIZED PIPE PILES</u>.

	PILE P	OINT LAYOUT	
157	PILES	357585.6161	623948.1459
158	PILES	357622.4601	623940.4307
159	PILES	357617.1578	623930.7930
160	PILES	357625.9647	623938.5026
161	PILES	357620.6625	623928.8649
162	PILES	357657.5065	623921.1498
163	PILES	357652.2042	623911.5120
164	PILES	357661.0100	623919.2197
165	PILES	357655.9487	623910.0198
166	PILES	357668.8962	623914.8829
167	PILES	357663.8350	
168			623905.6832 623896.7804
	PILES	357658.9395	
169	PILES	357676.7825	623910.5462
170	PILES	357671.7215	623901.3467
171	PILES	357666.8258	623892.4437
172	PILES	357684.6690	623906.2097
173	PILES	357679.6078	623897.0100
174	PILES	357674.7121	623888.1071
175	PILES	357692.5557	623901.8739
176	PILES	357687.4945	623892.6742
177	PILES	357696.0575	623899.9407
178	PILES	357690.7554	623890.3031
179	PILES	357727.5992	623882.5878
180	PILES	357722.2969	623872.9501
181	PILES	357731.1038	623880.6597
182	PILES	357725.8016	623871.0220
183	PILES	357762.6456	623863.3069
184	PILES	357757.3433	623853.6692
185	PILES	357766.1490	623861.3766
186	PILES	357761.0881	623852.1773
187	PILES	357774.0353	623857.0400
188	PILES	357768.9744	623847.8406
189	PILES	357764.0786	623838.9375
190	PILES	357781.9216	623852.7033
191	PILES	357776.8607	623843.5040
192	PILES	357771.9648	623834.6009
193	PILES	357789.8079	623848.3667
194	PILES	357784.7470	623839.1673
195	PILES	357779.8511	623830.2642
196	PILES	357797.6920	623844.0259
197	PILES	357792.6338	623834.8316
198	PILES	357801.1966	623842.0978
199	PILES	357795.8946	623832.4605
200	PILES	357832.7383	623824.7450
	PILES		
201		357827.4360	623815.1072
202	PILES	357836.2430	623822.8169
203	PILES	357830.9407	623813.1791
204	PILES	357867.7847	623805.4640
205	PILES	357862.4824	623795.8263
206	PILES	357871.2893	623803.5359
207	PILES	357865.9871	623793.8982
208	PILES	357902.8311	623786.1830
209	PILES	357897.5288	623776.5453
	PILES	357906.3357	623784.2549
210			

REVISIONS:	ONS:	
DATE:	DESCRIPTION:	

KILLENS POND STATE PARK ELEVATED WALKWAY **ELEVATED WALKWAY DETAILS**

CIVIL ENGINEER:

CENTURY ENGINEERING CONSULTING ENGINEERS, SURVEYORS 4134 N. DUPONT HWY. DOVER, DELAWARE 19901

CEI CONTRACT NO.: 175013.11



DESIGNED BY:

DRAWN BY: JSW

CHECKED BY:


DATE:


AUGUST 2020


SCALE: **AS SHOWN**

SHEET NO.:

CONTRACT NO.: 2020-KP-100

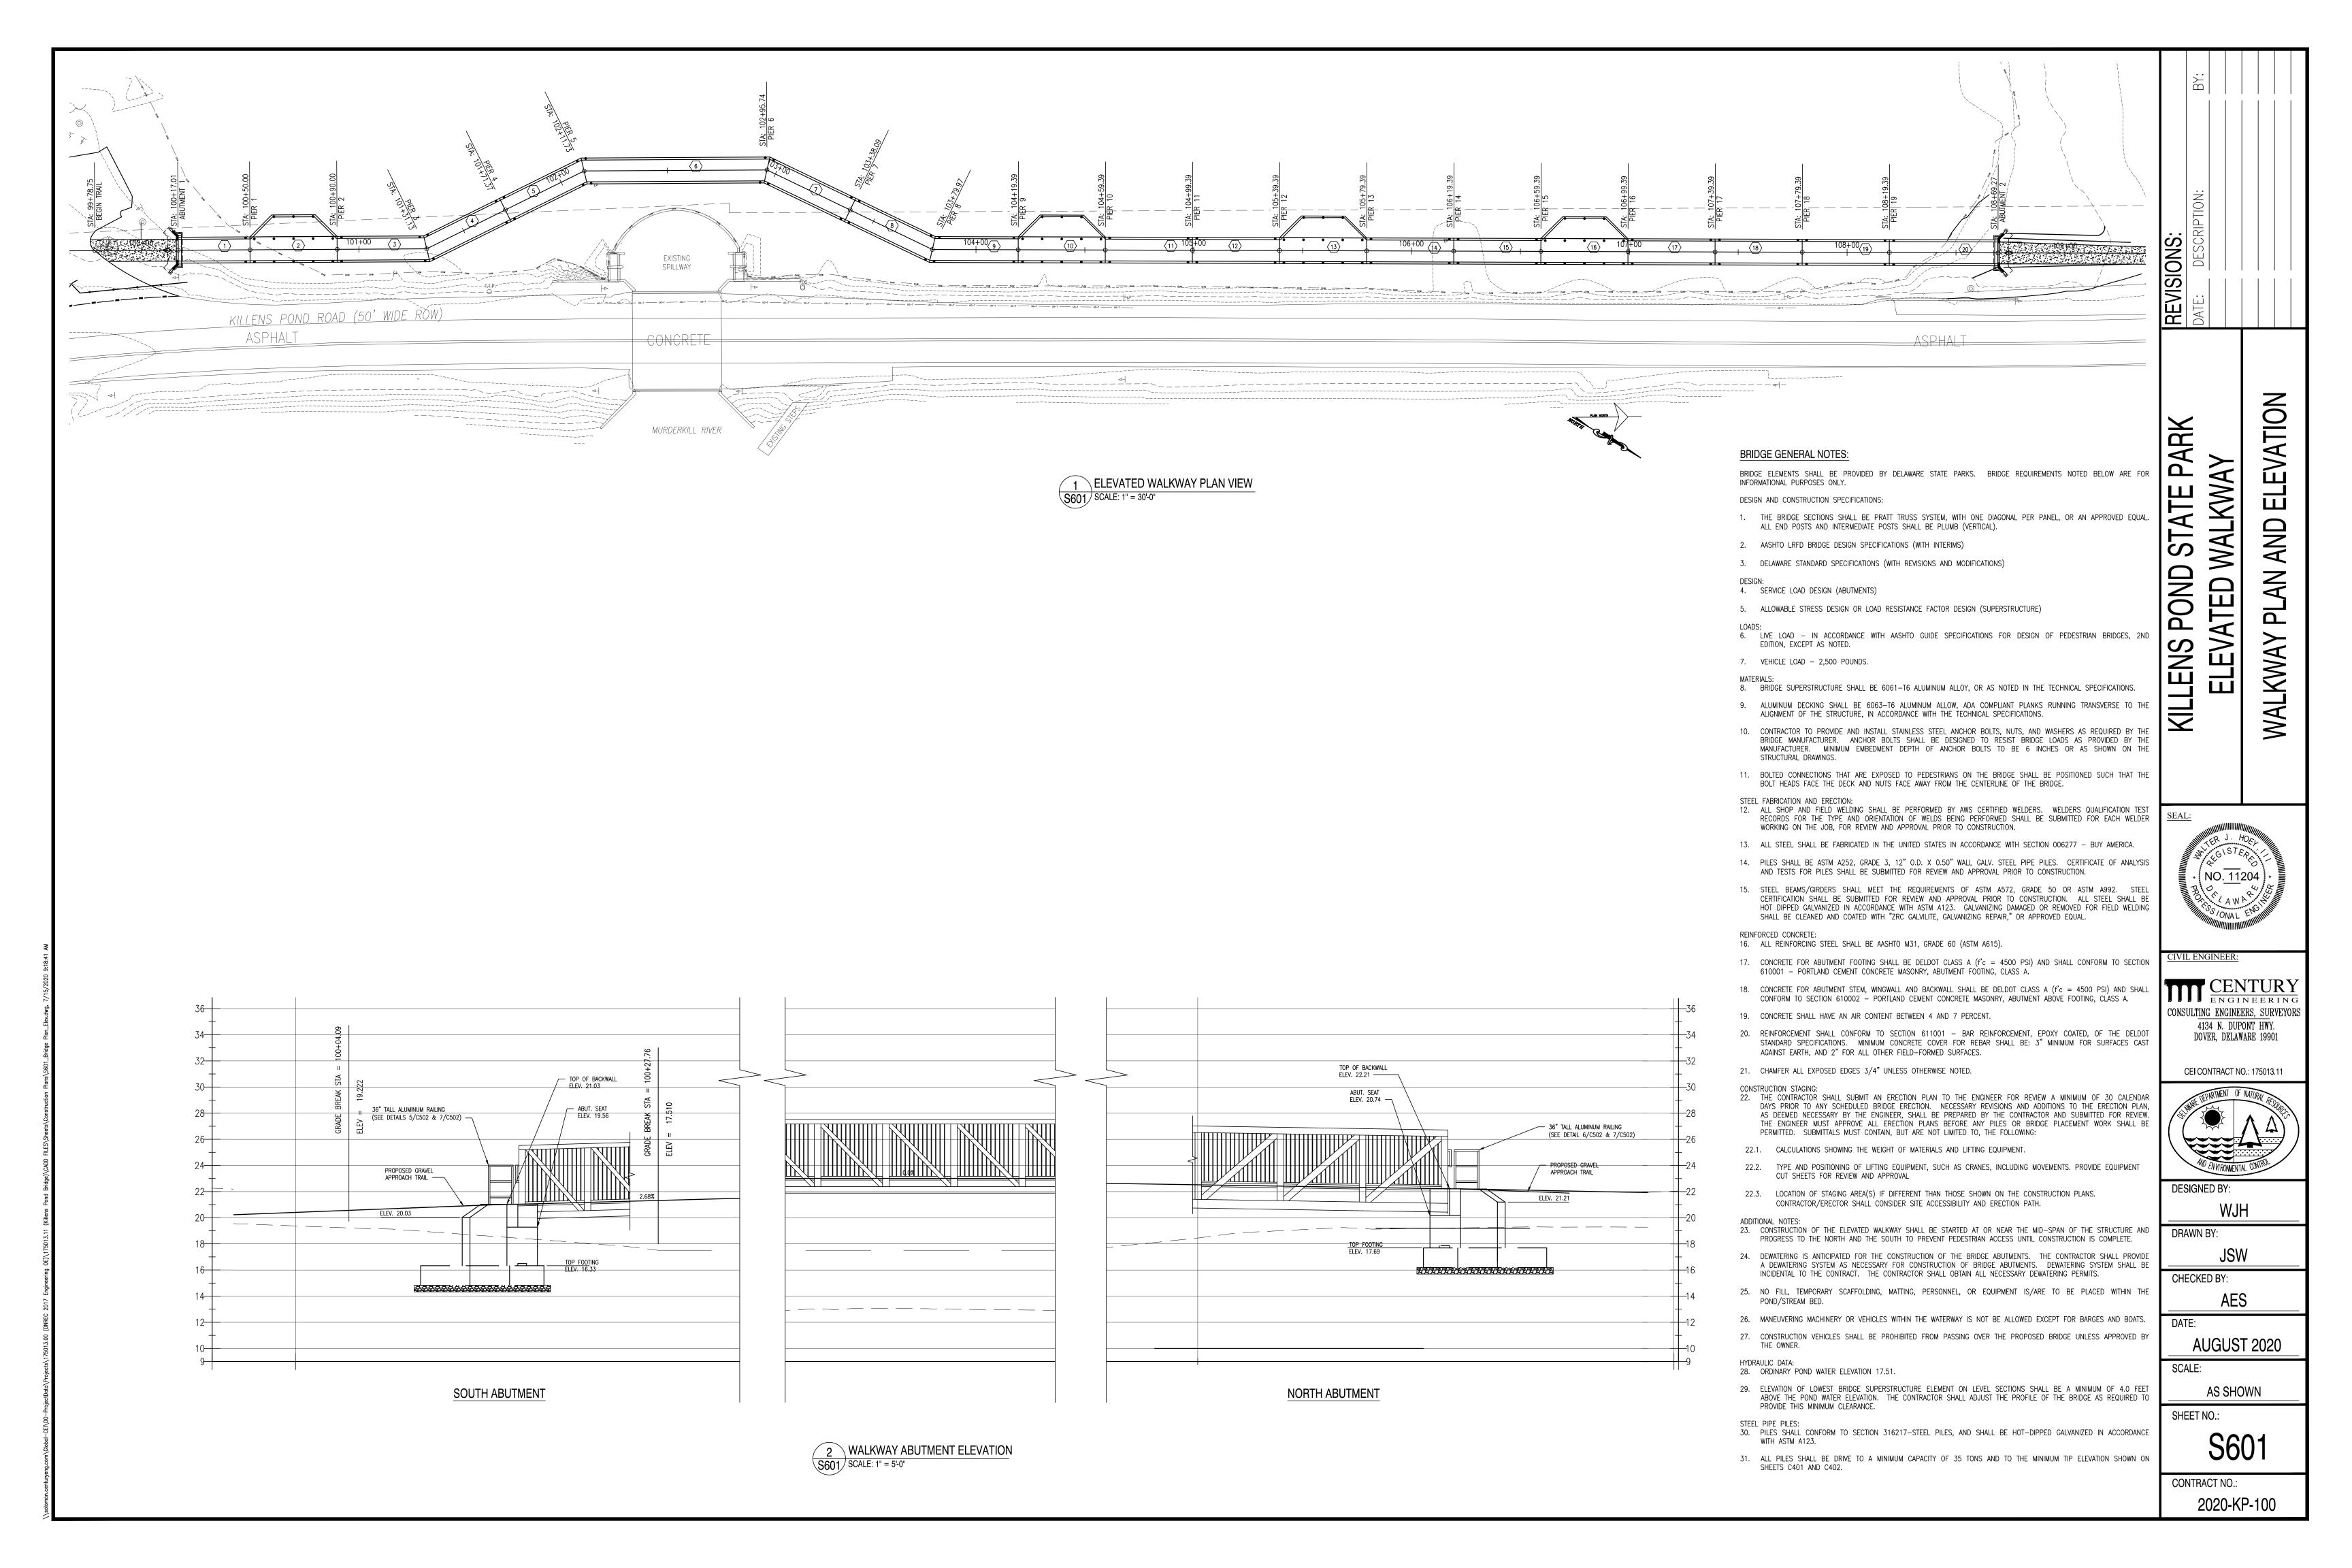

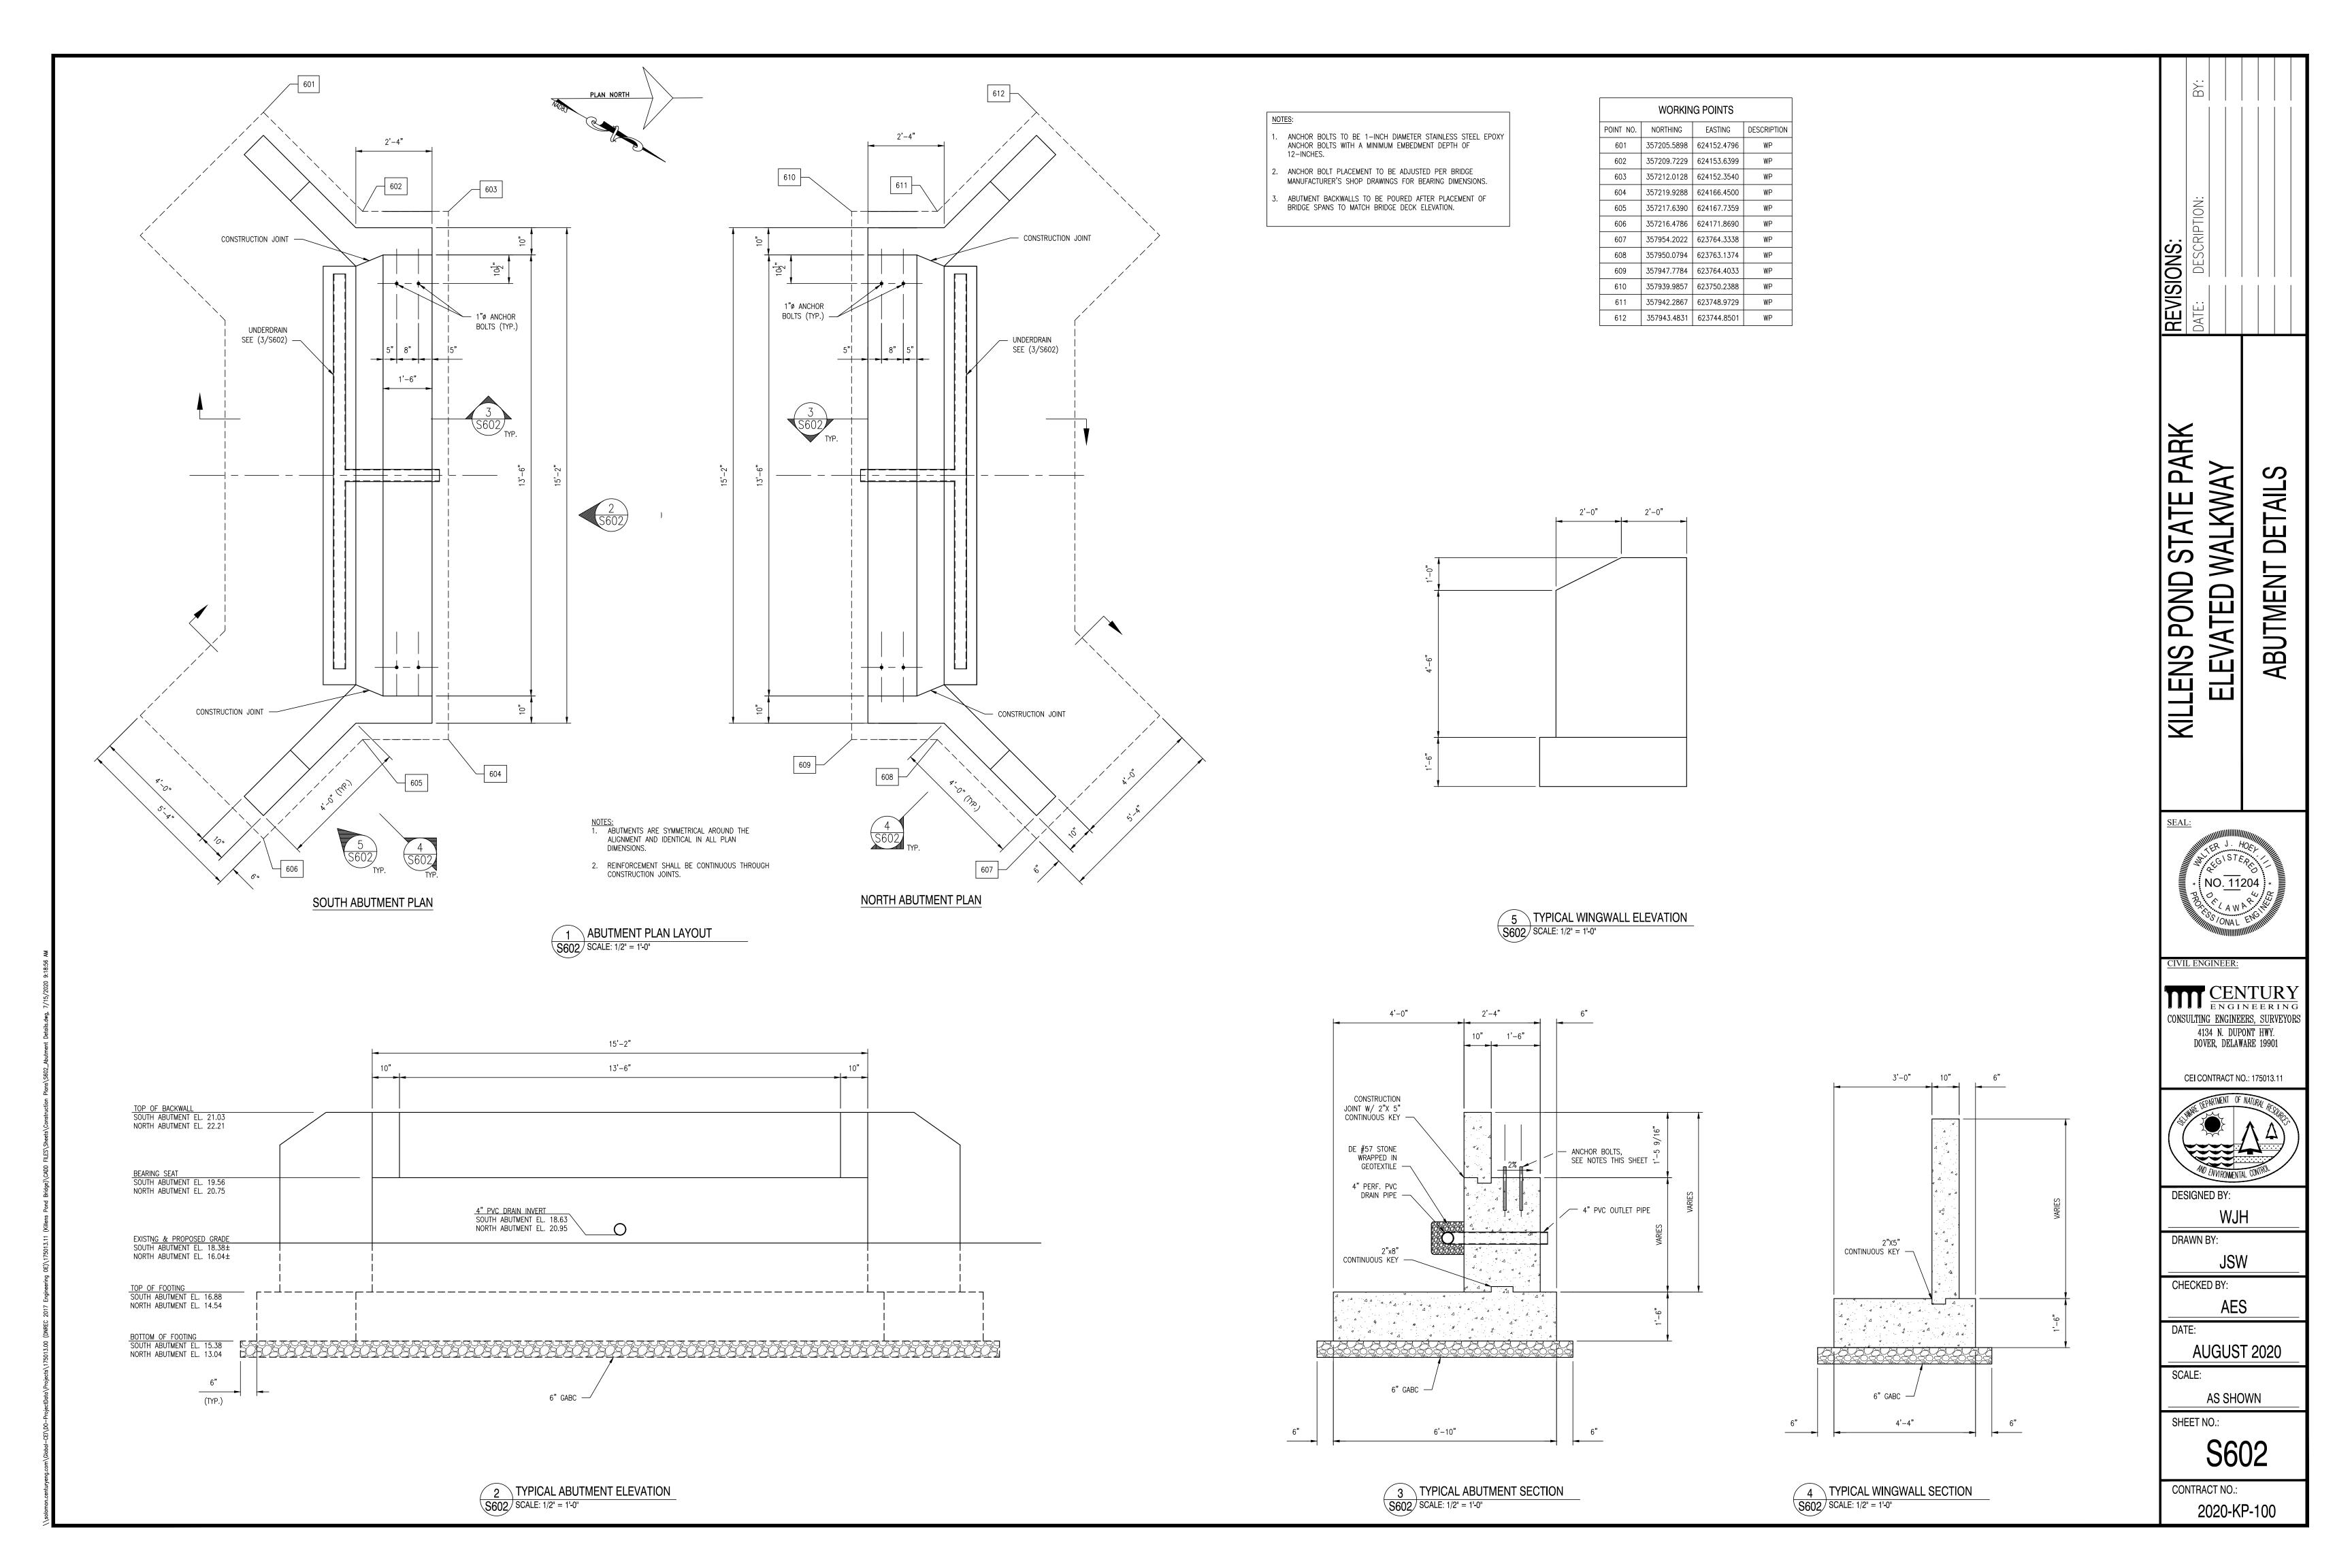

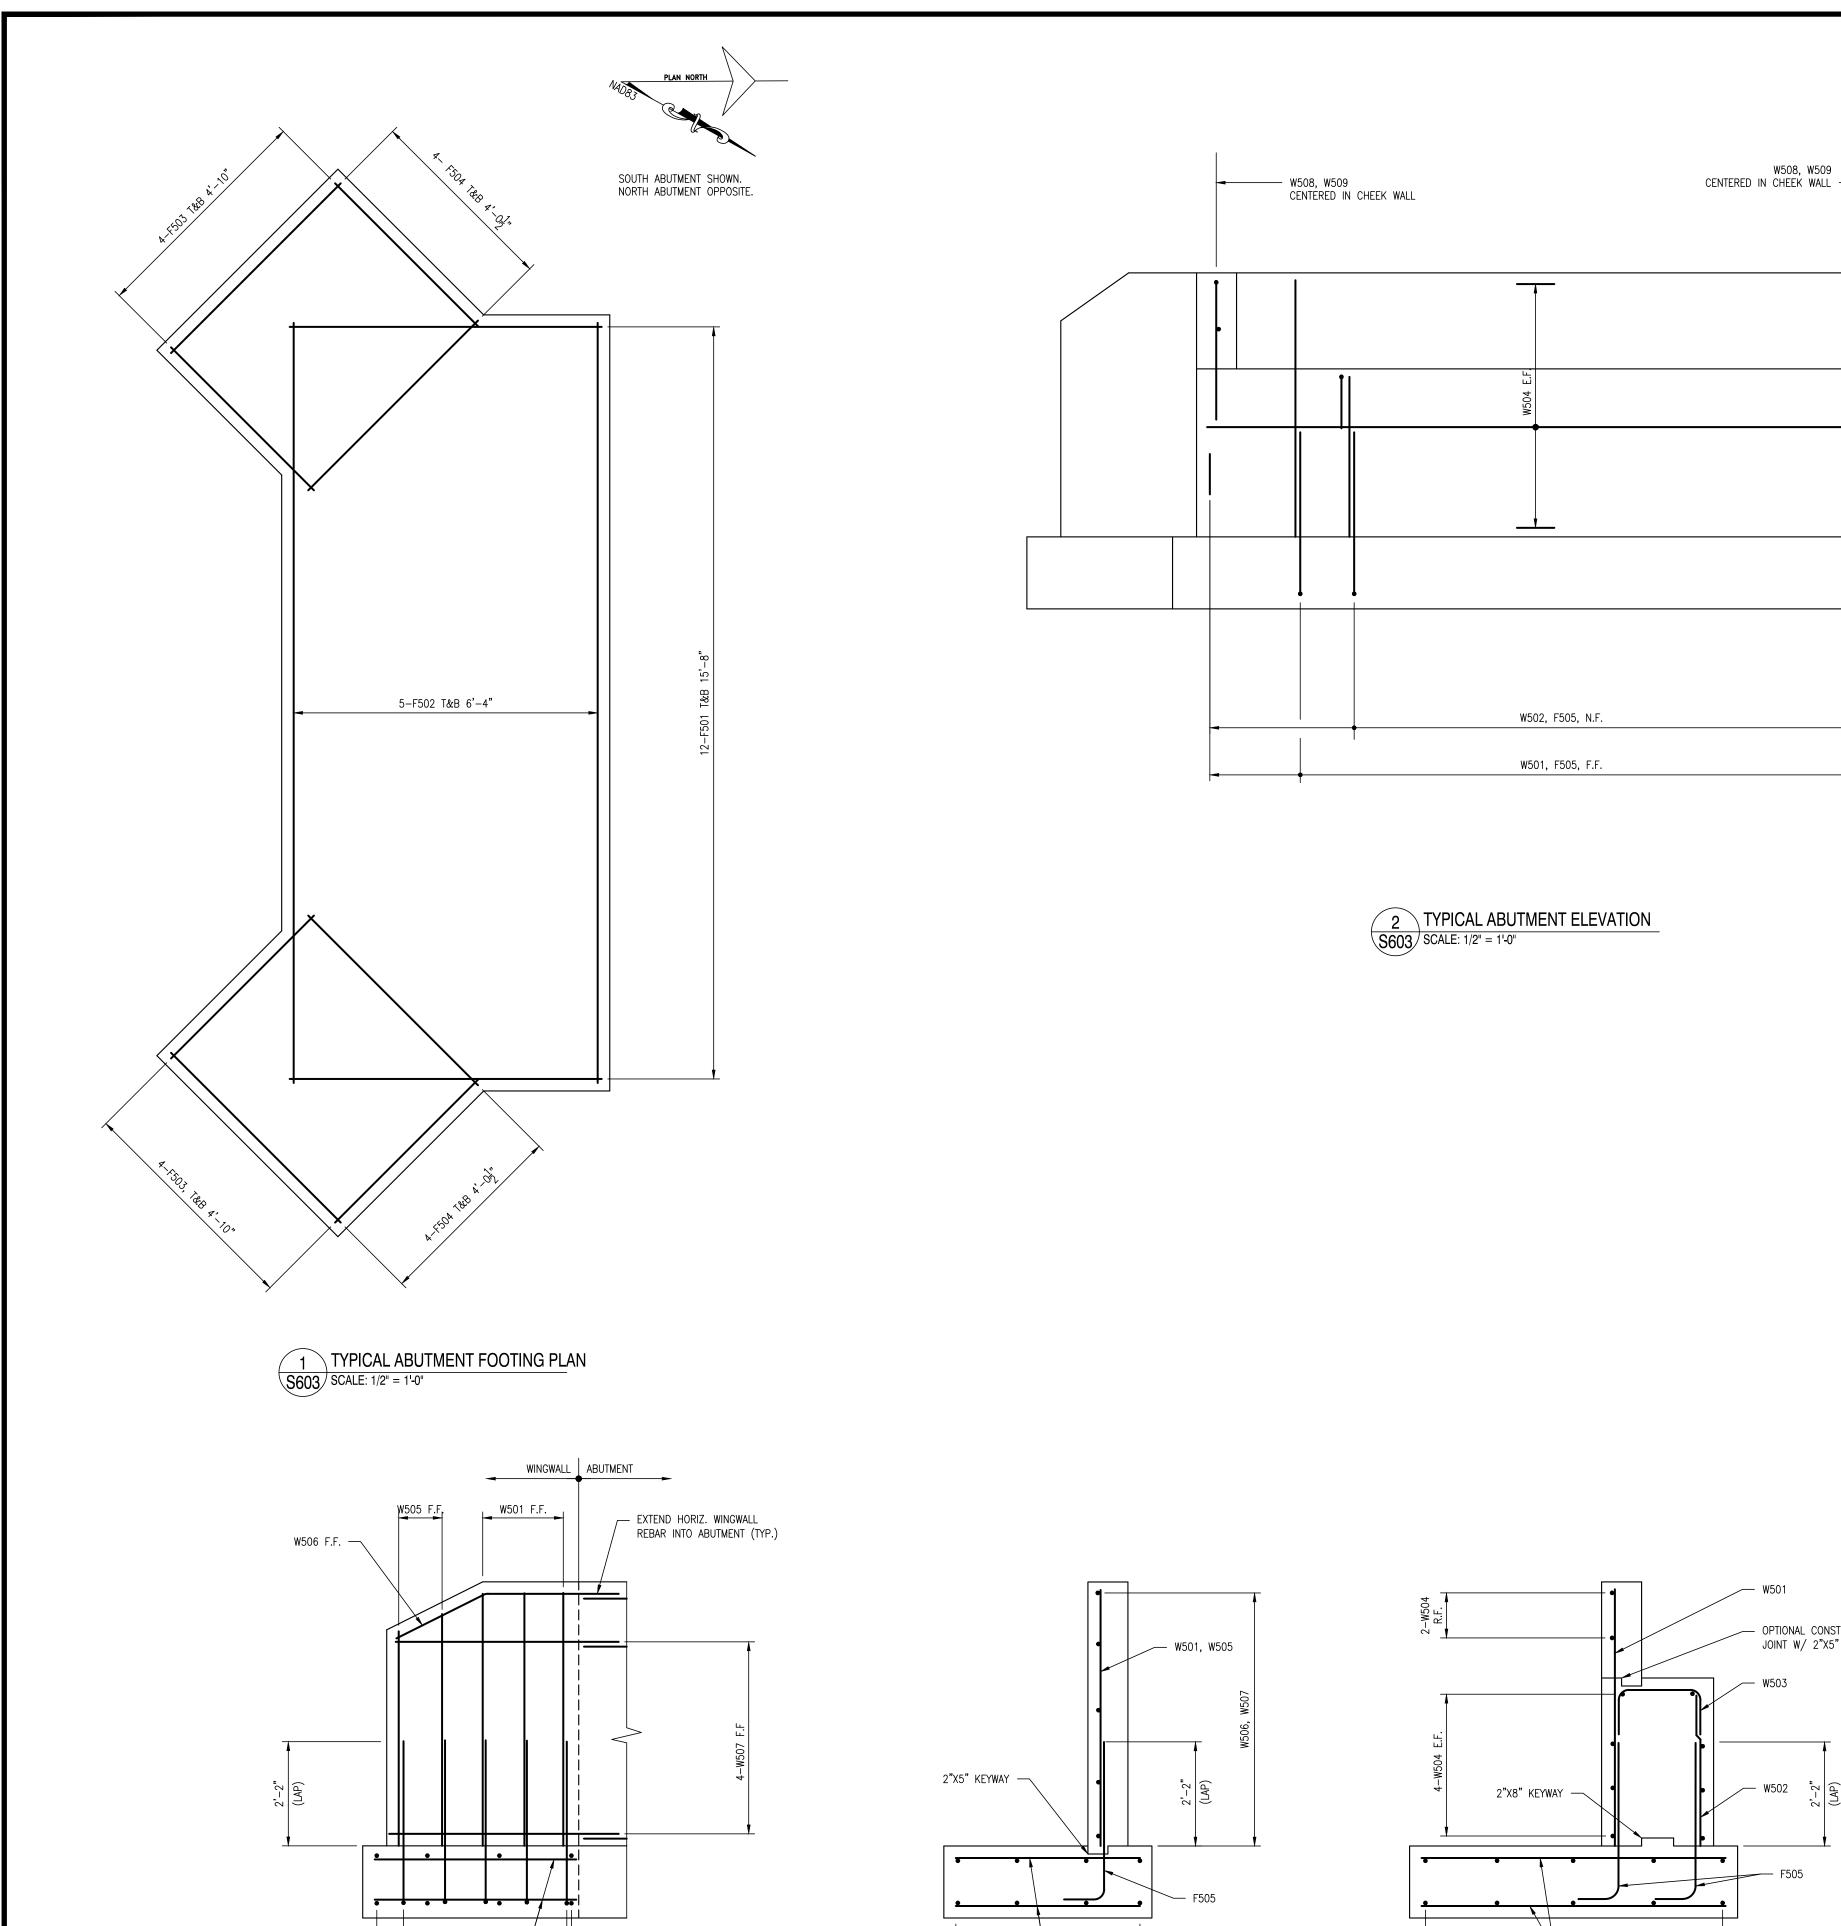

└─ F503, T&B

4 TYPICAL WINGWALL REBAR DETAIL S603 SCALE: 1/2" = 1'-0"


4-F504, T&B

F504 T&B ─

3 TYPICAL WINGWALL REBAR ELEVATION SCALE: 1/2" = 1'-0"

5-F505, F.F. (TYP.)

F503 T&B

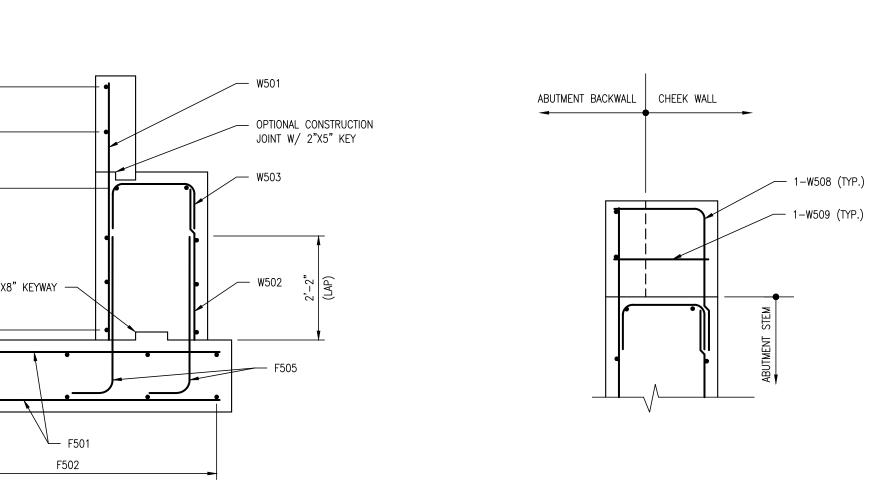

5 ABUTMENT REBAR DETAIL
S603 SCALE: 1/2" = 1'-0"

W508, W509

6 CHEEK WALL REBAR DETAIL
SCALE: 1/2" = 1'-0"

NOTE: SEE DETAIL 3/S603 FOR WINGWALL REINFORCEMENT DETAILS

MARK SIZE NO. LENGTH

F501 5 48 6'-4"

F502 5 20 15'-8" F503 5 32 4'-0 1/2 F504 5 32 4'-10" F505 5 48 4'-0 1/2

REBAR SCHEDULE (QUANTITIES SHOWN ARE FOR TWO ABUTMENTS)

48 4'-0 1/2" 2

36 5'-3 1/4" STR

5 8 (4'-4" TO STR

5 4 4'-10" 5 4 2'-0"

STR


STR

REINFORCEMENT ABBREVIATIONS

NEAR FACE FAR FACE EACH FACE 0.C. T&B ON CENTER TOP AND BOTTOM FOOTING ABUTMENT

WINGWALL HORIZ. HORIZONTA VERT. VERTICAL HORIZONTAL

BAR BENDS

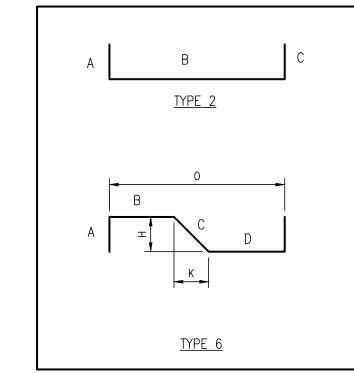

TYPE A B C D E F G H K REMARKS

REBAR NOTES:

1. UNLESS OTHERWISE NOTED, THE FOLLOWING MINIMUM CONCRETE COVER SHALL BE PROVIDED FOR REINFORCEMENT:

1.1. CONCRETE CAST AGAINST AND PERMANENTLY EXPOSED TO EARTH 3 INCHES.

1.2. CONCRETE EXPOSED TO EARTH OR WEATHER:

1.2.1. PRIMARY REINFORCEMENT 2 INCHES.

1.2.2. STIRRUPS, TIES, AND SPIRALS 1 ½ INCHES.

2 SETS, 2 EACH SET

REVISIONS:

DATE: DESCR


KILLENS POND STATE PARK

ELEVATED WALKWAY

REINFORCEMENT DETAILS

CIVIL ENGINEER:

CENTURY ENGINEERING CONSULTING ENGINEERS, SURVEYORS 4134 N. DUPONT HWY. DOVER, DELAWARE 19901

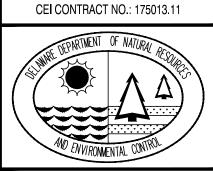

DESIGNED BY:

DRAWN BY:

JSW CHECKED BY:

AES


AUGUST 2020


SCALE:


AS SHOWN SHEET NO.:

S603

CONTRACT NO.: 2020-KP-100

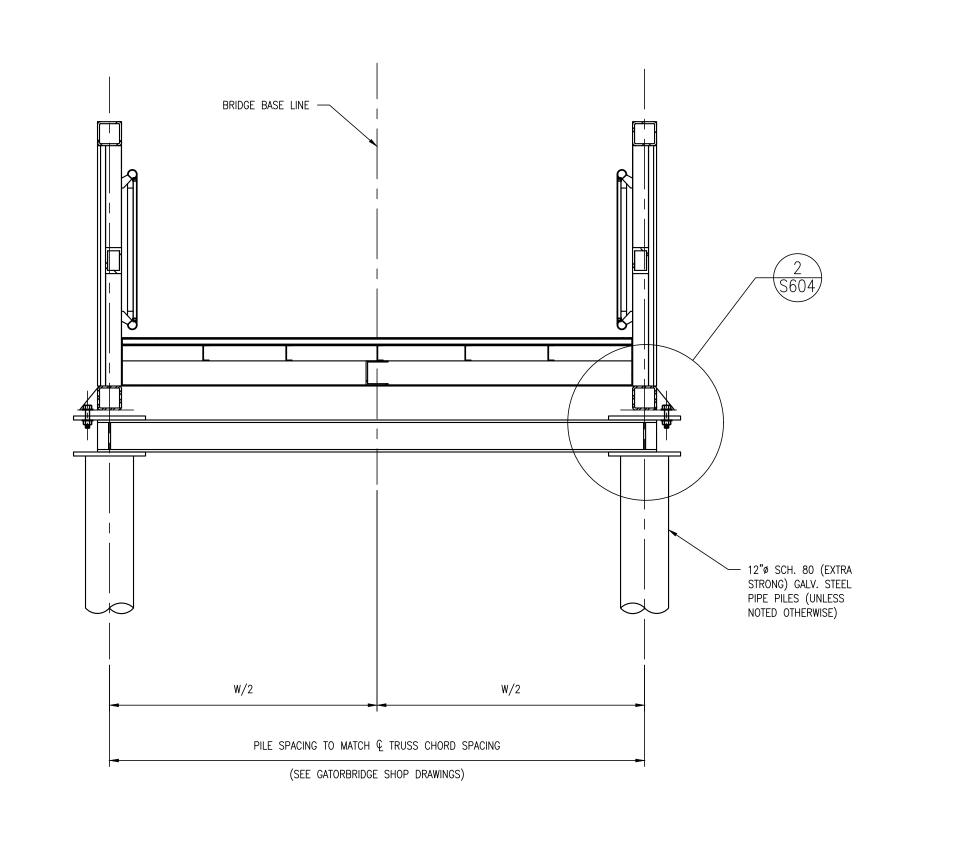

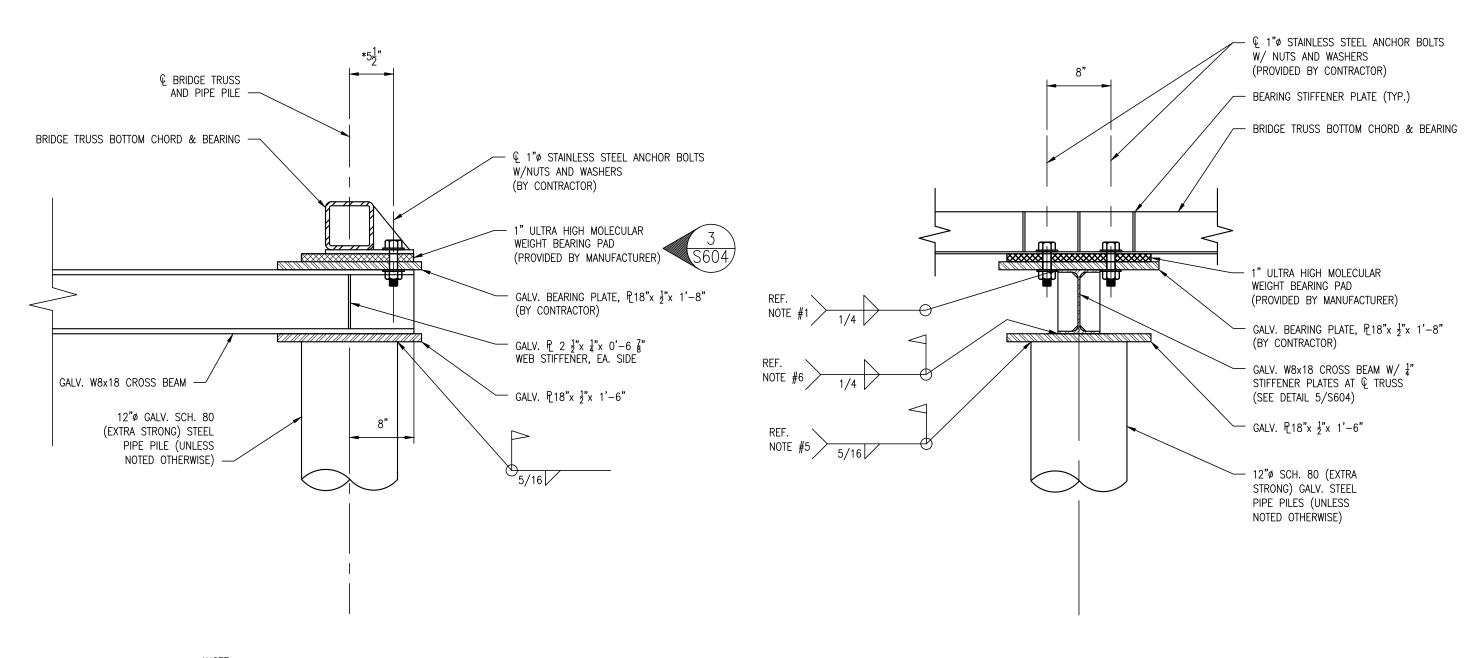

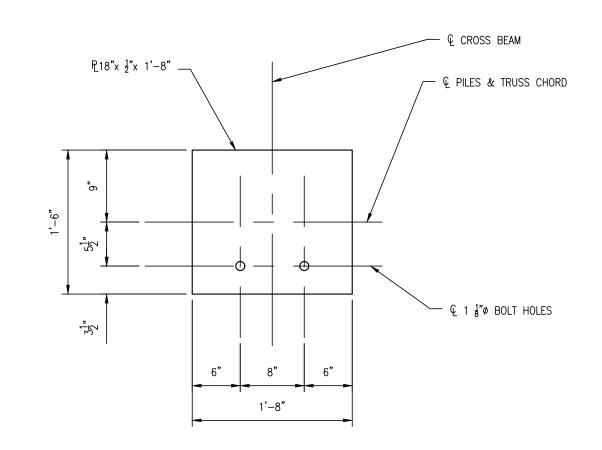


TYPICAL BRIDGE PIER
S604 SCALE: 1/2" = 1'-0"

2 BRIDGE TO PIER ATTACHMENT DETAIL S604 SCALE: 1" = 1'-0"

IN ACCORDANCE WITH MANUFACTURER'S SHOP DRAWINGS.



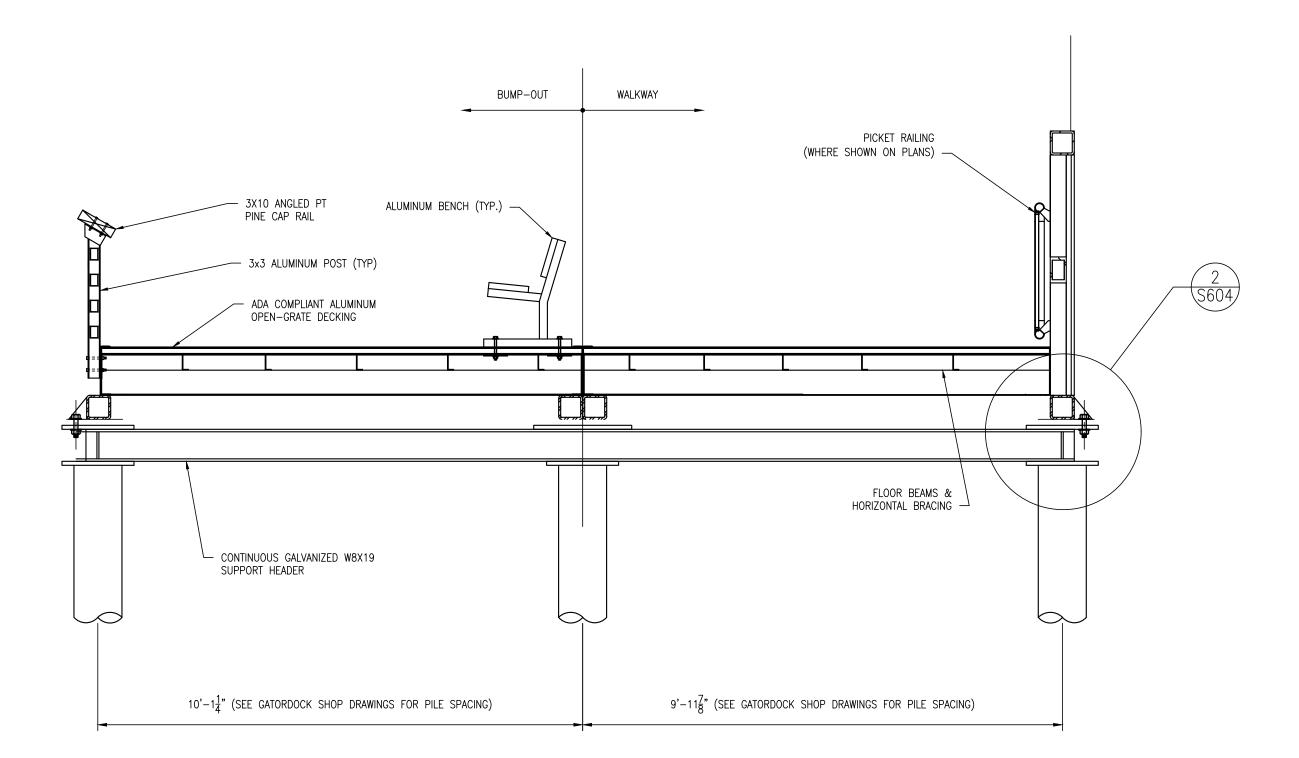

TYPICAL BUMP-OUT PIER

S604 SCALE: 1/2" = 1'-0"

W8x18 CROSS BEAM

P2 ½"x ¼"x 0'-7 ¾",

MILL TO BEAR

(TYP. EA. END)

5 TYPICAL BEARING STIFFENER S604 SCALE: 1 1/2" = 1'-0" BEARING PLATE PLAN
SCALE: 1" = 1'-0"

SUGGESTED PIER BENT SEQUENCE OF CONSTRUCTION:

- 1. SHOP WELD CROSS BEAMS TO BEARNG PLATES.
- 2. ATTACH/BOLT GALVANIZED CROSS BEAMS, ULTRA HIGH MOLECULAR WEIGHT BEARING PADS AND GALVANIZED $\frac{1}{2}$ 16"x $\frac{1}{2}$ "x 1'-6" PLATES TO WALKWAY BEARINGS PADS.
- 3. DRIVE GALVANIZED STEEL PIPE PILES AT LOCATIONS SHOWN ON CONTRACT PLANS AND PER GATORDOCK SHOP DRAWINGS TO MATCH WALKWAY BEARING PLATE LOCATIONS. PILES SHALL BE DRIVEN TO REQUIRED TIP ELEVATION.
- 4. CUT OFF TOPS OF PILES TO REQUIRED ELEVATION(S).
- 5. WELD PILE CAP ($\frac{1}{2}$ 18"x $\frac{1}{2}$ "x 1'-6") TO TOP OF PILES.
- 6. PLACE WALKWAY WITH CROSS BEAM ON TOP OF PILE CAPS AND WELD IN PLACE.
- 7. TIGHTEN ATTACHMENT BOLTS AS REQUIRED.
- 8. CLEAN WELDS AND COAT AREAS OF DAMAGED GALVANIZING IN ACCORDANCE WITH SECTION 316217 STEEL PILES.

NOTES:

1. ALL PILES SHALL BE 12"Ø GALVANIZED SCHEDULE 80 PIPE PILES <u>WITH THE EXCEPTION OF PILES SUPPORTING SPAN #6, WHICH SHALL BE 14"ØX 0.625" GALVANIZED PIPE PILES.</u>

SEAL:

NO. 11204

NO. 11204

NO. 11204

NO. 11204

ELEVATED WALKWAY

ETAIL(

EN

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PIER

REVISIONS:
DATE: DESCR

PARK


STATE

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CIVIL ENGINEER:

CENTURY
ENGINEERING
CONSULTING ENGINEERS, SURVEYORS
4134 N. DUPONT HWY.
DOVER, DELAWARE 19901

CEI CONTRACT NO.: 175013.11

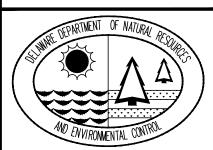

DESIGNED BY:

DRAWN BY:

JSW

CHECKED BY:

AES

DATE:

AUGUST 2020

SCALE:
AS SHOWN

SHEET NO.:

S604

CONTRACT NO.: 2020-KP-100

	y-			
ASSOCIATES Century Epigneting 41-34 Note Dull-out Rightery Dover, Delivered 1901 Century-Ritlens Pond State Park Weterated Exp Project No. JDH-1078188 DESCRIPTION Brown, well to saturated, loose, fine to medium SAND, with trace sit Brown, saturated, very dense, fine to medium SAND, with trace sit Brown, saturated, very dense, fine to medium SAND, with trace sit Brown, saturated, very dense, fine to medium SAND, with trace sit Brown, saturated, recition sitt, clayery origenic Sit.T. Brown, saturated, recition sitt, sitty CLAY, with CHOCH SP 6 19-20-31 MetiOH 6 2-3-4 CHOCH SP 2-4 Section Sitty Si	HYNES & ASSOCIATES Century Engineering 410H North Culforth Hybrery Contury-Kilmen Pond State Park Waterside Exp. Project No. JDH-10/18/188 DESCRIPTION DESCRIPTION On the Control of t	ASSOCIATES Centry Topipearing 4194 North DuPront Highway Dover, Delaware 19901 Centry-Yelliens Port State Park Wateriolds Exp Project No: JOH-1018/188 DESCRIPTION DESCRIPT	ASSOCIATES Century-Rejerening Payore, Colleware 15001 Century-Rejerening Project No.: JDH-10/19/188 Project No.: JDH-10/19/188 DESCRIPTION DESC	KILLENS POND STATE PARK ELEVATED WALKWAY SOIL BORING LOGS HEVISIONS: DATE: DESCRIPTION: DATE: DESCRIP
HYNES ASSOCIATES Century Enjenceting 4134 North Delimentary Dover, Delaware 19801 Century-Killers Pord State Park Wateriack Exp Project No: JOH-10/16/168 DESCRIPTION DESC	ASSOCIATES Century Egineering 4SN North Duff-ort Highway Century-Cillers Front State Part Waterskie Exp Project No.: JOH-10/16/188 DESCRIPTION	ASSOCIATES Century Eighneering 41SH North Durbrie Highway ASSOCIATES Century Eighneering 41SH North Durbrie Highway ASSOCIATES Century Eighneering 41SH North Durbrie Highway Century-Killens Pond State Park Wattenside Exp Project No: JUH-10147189 DESCRIPTION DE	ASSOCIATES Century Engineering Dever, Deliverer 19091 Century Figer No. JOH-101/818 DESCRIPTION DESCRIPTION	CIVIL ENGINEER: CIVIL ENGINEER: CONSULTING ENGINEERS, SURVEYOR A134 N. DUPONT HWY. DOVER, DELAWARE 19901 CEI CONTRACT NO.: 175013.11 DESIGNED BY: WJH DRAWN BY: JSW CHECKED BY: AES DATE: AUGUST 2020 SCALE: AS NOTED SHEET NO.: 2020-KP-100

DATA COLUMN COUNTY TAX MAP: 8-00-149.00-01-15.00-0000 6-00-149.00-01-19.00-0000 6-00-149.00-01-44.00-0000 DNREC PROJECT NUMBER: ADDRESS OF SITE: 5025 KILLENS POND ROAD FELTON, DE 19943 3. ZONING: EXISTING: AC-AGRICULTURAL CONSERVATION PROPOSED: AC- AGRICULTURAL CONSERVATION 4. SOURCE OF TITLE: D.B. 44150 LOT AREA: 429.24 AC 6. EXISTING USE: STATE PARK PROPOSED USE STATE PARK WITH ELEVATED WALKWAY 8. ELECTRIC: NONE 9. SEWER: 10. WATER: 11. DATUM: VERTICAL - NAVD 88 HORIZONTAL - NAVD 83 12. SITE CONDITIONS WITHIN LIMITS OF DISTURBANCE (ACRES) ALUMINUM WALKWAY 0.00 ACRES ALUMINUM WALKWAY 0.01 ACRES 0.00 ACRES 0.02 ACRES BRUSH BRUSH 0.03 ACRES GRAVEL <u>OPEN AREA</u> <u>OPEN AREA</u> IMPERVIOUS CONDITIONS EXISTING 9% PROPOSED 18% PER FIRM MAP NUMBER 10001C0335J, DATED JULY 7, 2014, THIS SITE LIES WITHIN ZONE AE, AREA. (BFE = 17.43 FEET) THE TOTAL LAND DISTURBANCE PROPOSED BY THIS PLAN IS 0.34± ACRES 15. LIMITS OF CONSTRUCTION THE TOTAL LIMITS OF CONSTRUCTION FOR THE SITE IS 0.60± ACRES WETLANDS THE TOTAL WETLANDS EXISTING WITHIN THE LIMITS OF DISTURBANCE IS 0.00± ACRES (000± S.F.) DNREC, DIVISION OF PARKS & RECREATION 89 KINGS HIGHWAY, DOVER, DE 19901 PHONE: 302-739-9210 FAX: 302-739-3817 18. CIVIL ENGINEER: CENTURY ENGINEERING, INC. 4134 NORTH DUPONT HIGHWAY, DOVER, DE 19901 WALTER J. HOEY, III, P.E. PHONE: (302) 734-9188 FAX: (302) 734-4589 **GENERAL NOTES** 1. THE DNREC SEDIMENT AND STORMWATER MANAGEMENT PROGRAM MUST BE NOTIFIED IN WRITING FIVE (5) DAYS PRIOR TO COMMENCING WITH CONSTRUCTION. FAILURE TO DO SO CONSTITUTES A VIOLATION OF THE APPROVED SEDIMENT AND STORMWATER MANAGEMENT PLAN. REVIEW AND APPROVAL OF THE SEDIMENT AND STORMWATER MANAGEMENT PLAN SHALL NOT RELIEVE THE CONTRACTOR FROM HIS OR HER RELIEVE THE CONTRACTOR FROM ERRORS OR OMISSIONS IN THE APPROVED PLAN.

- 3. IF THE APPROVED PLAN NEEDS TO BE MODIFIED, ADDITIONAL SEDIMENT AND STORMWATER CONTROL MEASURES MAY BE REQUIRED AS DEEMED NECESSARY BY DNREC OR THE DELEGATED AGENCY.
- 4. FOLLOWING THE SOIL DISTURBANCE OR REDISTURBANCE, PERMANENT OR TEMPORARY STABILIZATION SHALL BE COMPLETED FOR ALL PERIMETER SEDIMENT CONTROLS, SOIL STOCKPILES, AND ALL OTHER DISTURBED OR GRADED AREAS ON THE PROJECT SITE WITHIN 14 CALENDAR DAYS UNLESS MORE RESTRICTIVE FEDERAL REQUIREMENTS APPLY.
- 5. ALL EROSION AND SEDIMENT CONTROL PRACTICES SHALL COMPLY WITH THE DELAWARE EROSION AND SEDIMENT CONTROL HANDBOOK, LATEST
- 6. AT ANY TIME A DEWATERING OPERATION IS USED, IT SHALL BE PREVIOUSLY APPROVED BY THE AGENCY CONSTRUCTION SITE REVIEWER FOR A NON-EROSIVE POINT OF DISCHARGE, AND A DEWATERING PERMIT SHALL BE APPROVED BY THE DNREC WELL PERMITTING BRANCH.
- APPROVAL OF A SEDIMENT AND STORMWATER PLAN DOES NOT GRANT OR IMPLY A RIGHT TO DISCHARGE STORMWATER RUNOFF. THE OWNER/DEVELOPER IS RESPONSIBLE FOR ACQUIRING ANY AND ALL AGREEMENTS, EASEMENTS, ETC., NECESSARY TO COMPLY WITH STATE DRAINAGE AND OTHER APPLICABLE LAWS.
- 8. THE CONTRACTOR SHALL AT ALL TIMES PROTECT AGAINST SEDIMENT OR DEBRIS LADEN RUNOFF OR WIND FROM LEAVING THE SITE. PERIMETER CONTROLS SHALL BE CHECKED DAILY AND ADJUSTED AND/OR REPAIRED TO FULLY CONTAIN AND CONTROL SEDIMENT FROM LEAVING THE SITE. ACCUMULATED SEDIMENT SHALL BE REMOVED WHEN IT HAS REACHED HALF OF THE EFFECTIVE CAPACITY OF THE CONTROL. IN ADDITION, THE CONTRACTOR MAY NEED TO ADJUST OR ALTER MEASURES IN TIMES OF ADVERSE WEATHER CONDITIONS, OR AS DIRECTED BY THE AGENCY
- BEST AVAILABLE TECHNOLOGY (BAT) SHALL BE EMPLOYED TO MANAGE TURBID DISCHARGES IN ACCORDANCE WITH REQUIREMENTS OF 7 DEL C. CHAPTER 60, REGULATIONS GOVERNING THE CONTROL OF WATER POLLUTION, SECTION 9.1.02, KNOWN AS SPECIAL CONDITIONS FOR STORMWATER DISCHARGES ASSOCIATED WITH CONSTRUCTION ACTIVITIES AND DEPARTMENT POLICIES, PROCEDURES, AND GUIDANCE.

KILLENS POND STATE PARK

SEDIMENT & STORMWATER MANAGEMENT PLANS

KILLENS POND STATE PARK **ELEVATED WALKWAY**


<u>ITEM</u>	EXISTING	PROPOSED
PARCEL LINE -		N/A
CONTOUR -		XX
TRAVERSE POINT	<u>5</u>	N/A
EDGE OF GRAVEL -		N/A
FENCE -	X X	N/A
TREELINE	~~~~~~~~~~~~~~~~~~~~~~~~~~~~~~~~~~~~~~~	N/A
TREE (DECIDUOUS)		N/A
TREE (CONIFEROUS)	*	N/A
BOLLARD	©	N/A
UTILITY POLE	Ø	N/A
WATER LINE -	— w — w — w —	— w— w— w— w
OVERHEAD ELECTRIC	N/A	———— OH-E
UNDERGROUND ELECTRIC -	UG-E	UG-E
SANITARY SEWER PIPE -	s s	— s— - s— s—
LIMIT OF DISTURBANCE -	LOD	N/A
SILT FENCE -	SF	N/A
STOCK PILE -	SP SP	N/A
LINE OF ANALYSIS -		N/A
PROPOSED DRAINAGE AREA -		N/A
EXISTING IMPERVIOUS COVER		N/A
PROPOSED IMPERVIOUS COVER		N/A

PROJECT NOTES


- 1. THE INTENT OF THIS PROJECT IS TO PROVIDE THE FOLLOWING IMPROVEMENTS AT THE KILLENS POND STATE PARK: 1.1. INSTALL ELEVATED WALKWAY AND APPROACHES.
- 2. THESE PLANS HAVE BEEN DEVELOPED IN ACCORDANCE WITH THE CURRENT EDITION OF THE "ACCESSIBILITY STANDARDS FOR
- 3. PARCEL AND BOUNDARY LINES REFERENCED FROM GIS INFORMATION. NO BOUNDARY SURVEY WAS REQUESTED OR PERFORMED
- 4. EXISTING UTILITIES SHOWN ARE BASED ON THE BEST INFORMATION AVAILABLE AT THE TIME THIS PLAN WAS DEVELOPED. COMPLETENESS OR CORRECTNESS OF THE UTILITIES SHOWN THEREOF IS NOT GUARANTEED. THE CONTRACTOR IS RESPONSIBLE FOR EMPLOYING AN UNDERGROUND UTILITY LOCATOR TO LOCATE AND MARK EXISTING UTILITIES WITHIN THE LIMIT OF DISTURBANCE PRIOR TO BEGINNING CONSTRUCTION. ALL EXISTING UTILITIES SHALL BE PROTECTED AND TEMPORARILY SUPPORTED OR RELOCATED AS NECESSARY TO COMPLETE THE WORK IN ACCORDANCE WITH THE PERTINENT OWNER/UTILITY COMPANY REQUIREMENTS. ANY UTILITIES DAMAGED BY THE CONTRACTOR SHALL BE PROMPTLY AND FULLY RESTORED TO THE SATISFACTION
- 5. TOPSOIL SHALL BE STRIPPED, STOCKPILED, AND STABILIZED FOR FUTURE USE IN ACCORDANCE WITH THE DELAWARE EROSION & SEDIMENT CONTROL HANDBOOK, CURRENT EDITION. STOCKPILE AREAS TO BE WITHIN TRAP POND STATE PARK AT LOCATIONS SHOWN ON THESE PLANS, OR AT AREAS DETERMINED BY THE ENGINEER IN THE FIELD.
- 6. TREES LOCATED WITHIN 5' OF THE LOC AND NOT DESIGNATED TO BE REMOVED SHALL BE PROTECTED FROM CONSTRUCTION EQUIPMENT AND COMPACTION OF SOIL WITHIN THE DRIP LINE BY MEANS OF 3'-0" HIGH SENSITIVE AREA PROTECTION (SAP) FENCE, AS SHOWN ON THE EROSION AND SEDIMENT CONTROL PLANS.
- 7. CROSS SLOPE OF ALL NEW WALKWAYS/SIDEWALKS SHALL NOT EXCEED A SLOPE OF 1:50. LONGITUDINAL SLOPES OF ALL NEW WALKWAYS AND TRAILS SHALL NOT EXCEED 1:20, UNLESS SHOWN OTHERWISE ON THE CONTRACT PLANS.
- 8. THE CONTRACTOR MAY STORE AND/OR STOCKPILE EQUIPMENT AND MATERIALS WITHIN THE PROJECT SITE LIMIT OF DISTURBANCE
- (LOD) SHOWN ON PLAN. 9. THE CONTRACTOR IS ADVISED THAT CONTRACTOR EMPLOYEE PARKING SHALL BE LIMITED TO THE EXISTING PARK PARKING AREAS,
- 10. FEATURES NOT SPECIFICALLY DESIGNATED FOR DEMOLITION OR REMOVAL THAT ARE DAMAGED BY THE CONTRACTOR OR THE CONTRACTOR'S SUBCONTRACTORS SHALL BE REPAIRED OR REPLACED BY THE CONTRACTOR AT NO ADDITIONAL COST TO THE
- 11. NO CONSTRUCTION, EQUIPMENT, WORK, OR TEMPORARY FILLS SHALL BE ALLOWED WITHIN WETLANDS OR WATERS EXCEPT WITHIN
- 12. WETLANDS DISTURBED BY CONSTRUCTION SHALL BE REPORTED TO DNREC, AND RESTORED TO MATCH ADJACENT AREA.

STATE. THE COST FOR REPAIRS OR REPLACEMENT SHALL BE ESTABLISHED BY THE STATE INSURANCE PROVIDER.

13. WORK HOURS: 8 AM TO 6 PM, MONDAY - FRIDAY UNLESS OTHERWISE APPROVED BY THE ENGINEER.

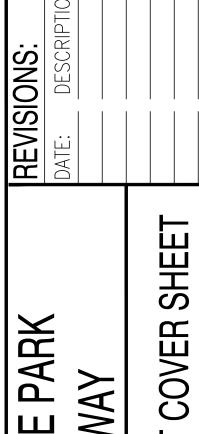


PA WALKW MANAGEMENT Ш STORMWATER

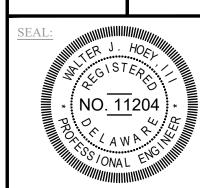

CENTURY ENGINEERING CONSULTING ENGINEERS, SURVEYORS 4134 N. DUPONT HWY. DOVER, DELAWARE 19901

CEI CONTRACT NO.: 175013.11

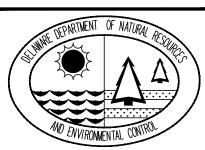

DESIGNED BY:

DRAWN BY:

CHECKED BY:

AUGUST 2020

SCALE:

2020-KPSP-100

OWNER/DEVELOPER CERTIFICATION

UNLESS APPROVED BY THE ENGINEER.


I, THE UNDERSIGNED, CERTIFY THAT ALL LAND CLEARING, CONSTRUCTION AND DEVELOPMENT SHALL BE DONE PURSUANT TO THE APPROVED PLAN AND THAT RESPONSIBLE PERSONNEL (I.E. BLUE CARD HOLDER) INVOLVED IN THE LAND DISTURBANCE WILL HAVE A CERTIFICATION OF TRAINING PRIOR TO INITIATION OF THE PROJECT, AT A DNREC SPONSORED OR APPROVED TRAINING COURSE FOR THE CONTROL OF EROSION AND SEDIMENT DURING CONSTRUCTION. IN ADDITION, I GRANT THE DNREC SEDIMENT AND STORMWATER PROGRAM AND/OR THE RELEVANT DELEGATED AGENCY THE RIGHT TO CONDUCT ON-SITE REVIEWS, AND I UNDERSTAND MY RESPONSIBILITIES UNDER THE NPDES CONSTRUCTION GENERAL PERMIT, AS REFERENCED ON


CONSTRUCTION PROJECT ADMINISTRATOR OFFICE OF DESIGN AND DEVELOPMENT DNREC - DIVISION OF PARKS AND RECREATION 89 KINGS HIGHWAY, DOVER, DE 19901 PHONE: 302-739-9210 FAX: 302-739-3817

CERTIFICATION OF PLAN ACCURACY

I, HEREBY CERTIFY THAT THIS PLAN HAS BEEN PREPARED UNDER MY SUPERVISION AND TO THE BEST OF MY KNOWLEDGE COMPLIES WITH THE APPLICABLE STATE AND LOCAL REGULATIONS AND ORDINANCES.

ALEX SCHMIDT, P.E., DE NO. 16139 CENTURY ENGINEERING, INC. 4134 NORTH DUPONT HIGHWAY DOVER, DELAWARE 19901 PHONE: (302) 734-9188 FAX: (302) 734-4589

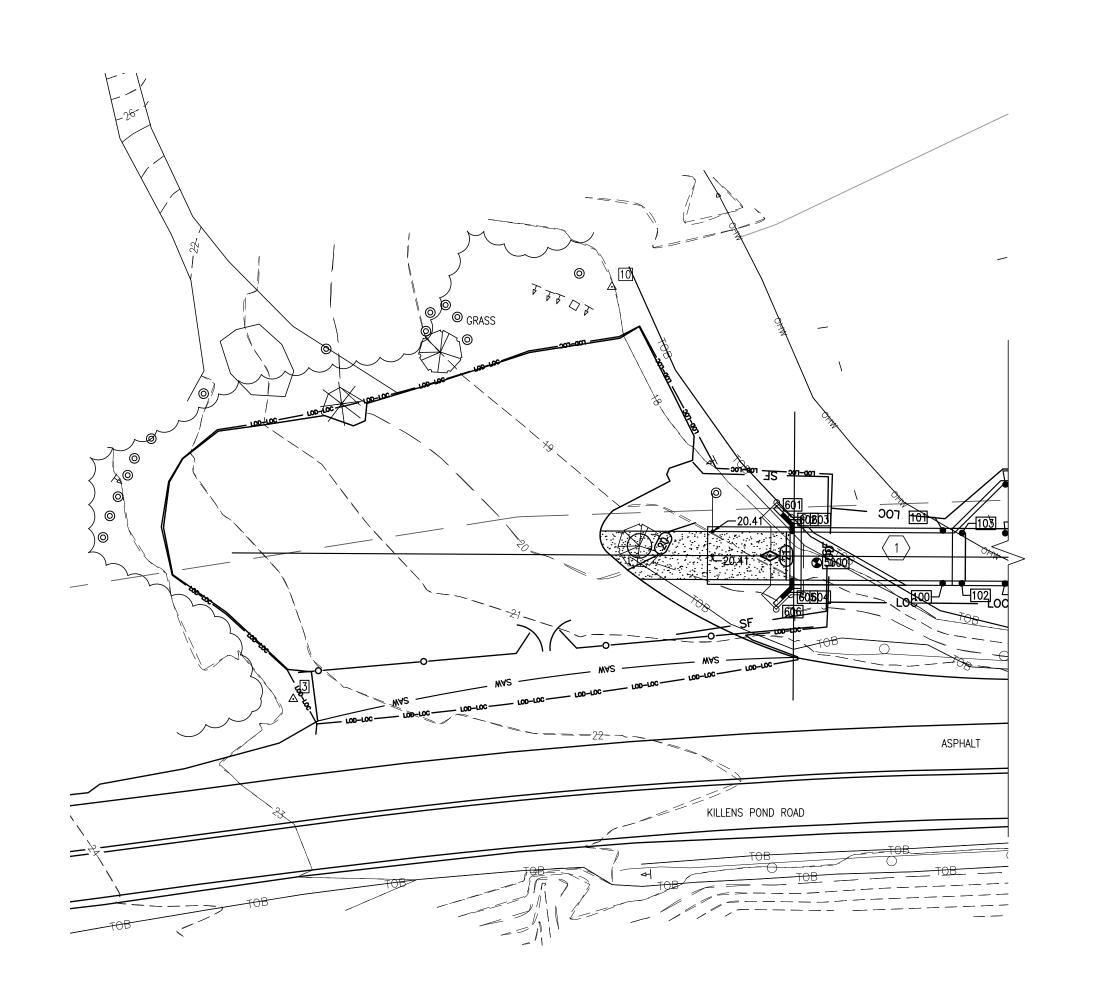

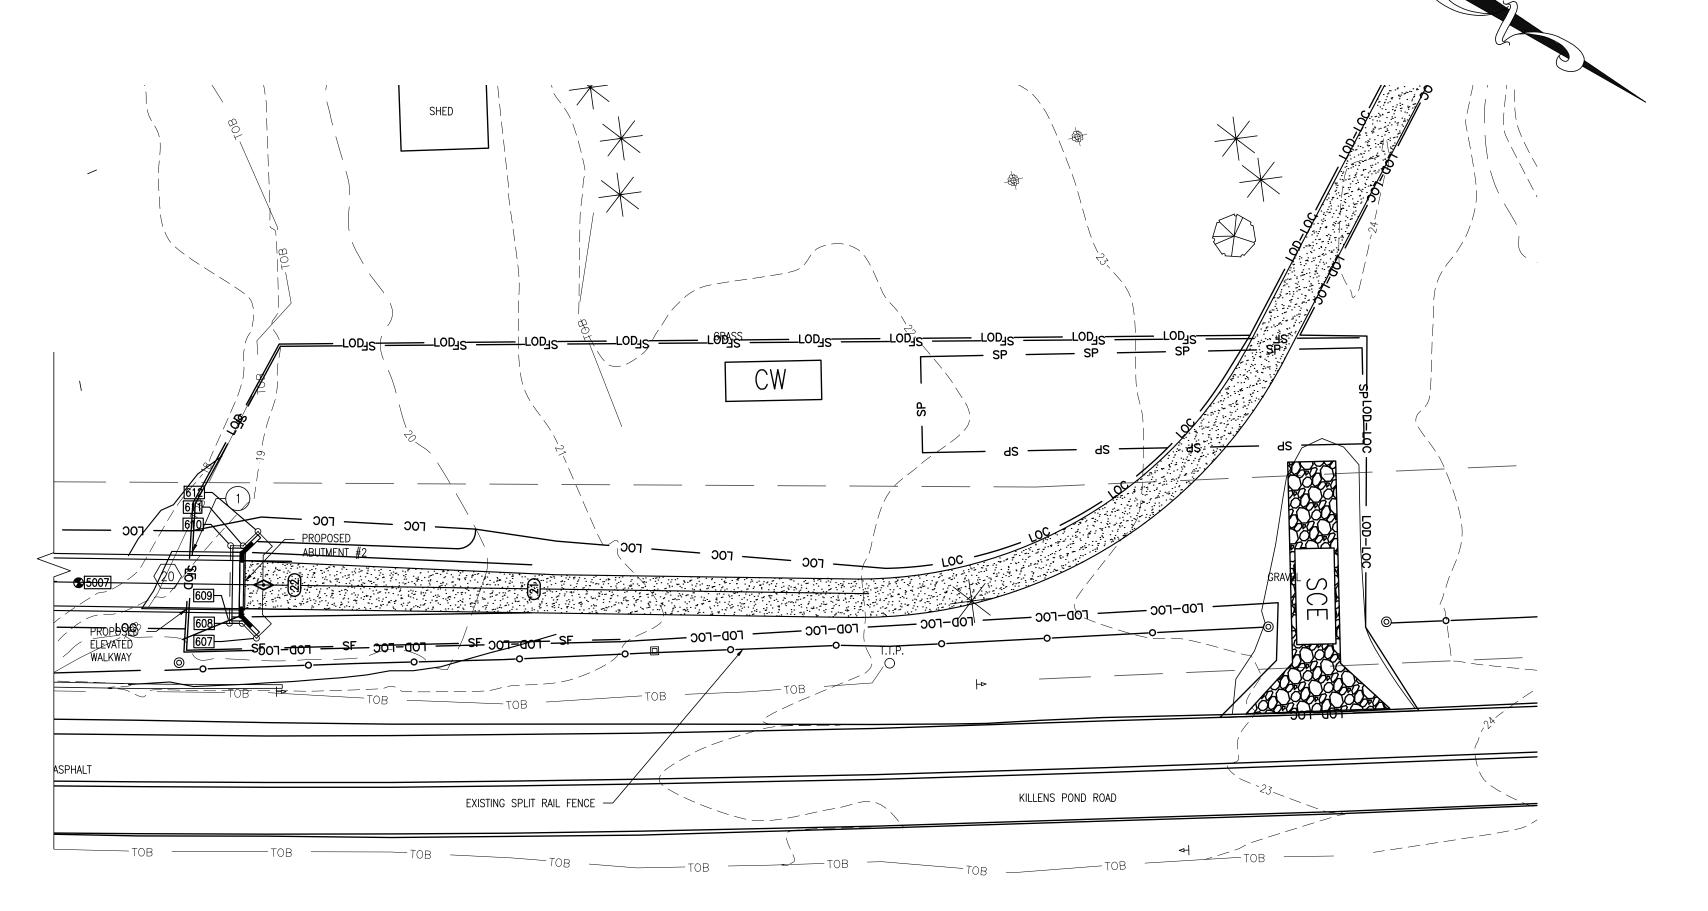

1 EROSION AND SEDIMENT CONTROL PLAN SCALE: 1" = 20'-0"

SEQUENCE OF CONSTRUCTION:

 NOTIFY THE DNREC SEDIMENT AND STORMWATER PROGRAM IN WRITING AT LEAST FIVE (5) DAYS PRIOR TO THE START OF CONSTRUCTION. FAILURE TO DO SO CONSTITUTES A VIOLATION OF THE APPROVED SEDIMENT AND STORMWATER MANAGEMENT PLAN.

- 2. PRIOR TO ANY CLEARING, INSTALLATION OF SEDIMENT CONTROL MEASURES OR GRADING, A PRECONSTRUCTION MEETING MUST BE SCHEDULED AND CONDUCTED WITH THE AGENCY CONSTRUCTION SITE REVIEWER. THE LANDOWNER/DEVELOPER, CONTRACTOR, AND CERTIFIED CONSTRUCTION REVIEWER ARE REQUIRED TO BE IN ATTENDANCE AT THE PRE—CONSTRUCTION MEETING; THE DESIGNER IS RECOMMENDED TO ATTEND.
- 3. CLEAR AND GRUB AS REQUIRED TO INSTALL PERIMETER CONTROLS. INSTALL PERIMETER CONTROLS. ALL PERIMETER CONTROLS ARE TO BE REVIEWED BY THE AGENCY CONSTRUCTION SITE REVIEWER AND APPROVED PRIOR TO PROCEEDING WITH FURTHER SITE DISTURBANCE OR CONSTRUCTION.
- 4. THE CONTRACTOR SHALL AT ALL TIMES PROTECT AGAINST SEDIMENT OR DEBRIS LADEN RUNOFF OR WIND FROM LEAVING THE SITE. PERIMETER CONTROLS SHOULD BE CHECKED DAILY AND ADJUSTED AND/OR REPAIRED TO FULLY CONTAIN AND CONTROL SEDIMENTATION ON THE SITE. ACCUMULATED SEDIMENT SHALL BE REMOVED WHEN IT HAS REACHED HALF OF THE EFFECTIVE CAPACITY OF THE CONTROL. IN ADDITION, THE CONTRACTOR MAY NEED TO ADJUST OR REPAIR MEASURES IN TIMES OF ADVERSE WEATHER CONDITIONS, OR AS DIRECTED BY THE AGENCY CONSTRUCTION SITE REVIEWER.
- 5. CONSTRUCT NEW ELEVATED WALKWAY AND APPROACHES.
- 6. STABILIZE ALL DISTURBED AREAS AND DISPOSED OF ALL EXCESS MATERIAL AT AN OFFSITE LOCATION IN COMPLIANCE WITH ALL APPLICABLE LAWS AND REGULATIONS.

STABILIZATION REQUIREMENTS:

- ALL DISTURBED AREAS SHALL BE STABILIZED WITH 6" TOPSOIL, DNREC SEDIMENT NO. 9, AND MULCH.
- 2. INSTALL STABILIZED CONSTRUCTION ENTRANCE AT EXISTING BREAK IN SPLIT RAIL FENCE AS SHOWN.

REVISIONS:

DATE: DESCRIPTION:

KILLENS POND STATE PARK ELEVATED WALKWAY

SEDIMENT CONTROL

EROSION AND

SEAL:

NO. 11204

NO. 11204

NO. 11204

NO. 11204

CIVIL ENGINEER:

CENTURY
ENGINEERING
CONSULTING ENGINEERS, SURVEYORS
4134 N. DUPONT HWY.
DOVER, DELAWARE 19901

CEI CONTRACT NO.: 175013.11



DESIGNED BY:

DRAWN BY:

DFS

CHECKED BY:

DATE:


AUGUST 2020
SCALE:


SHEET NO.:

1'' = 20'

SSMP50

CONTRACT NO.: 2020-KPSP-100

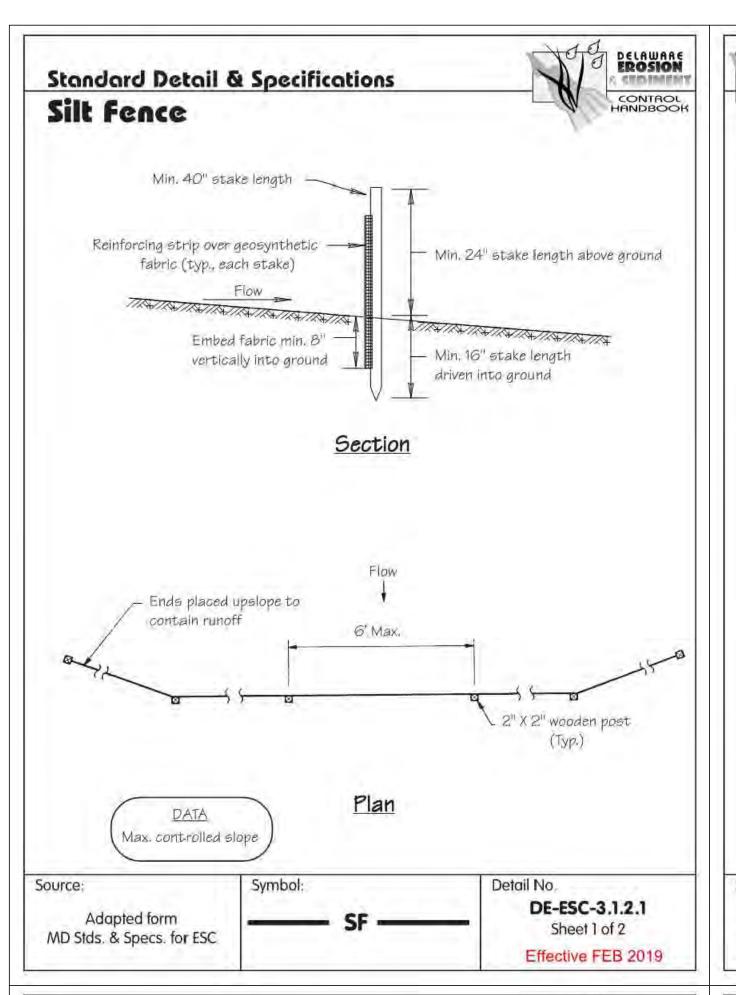

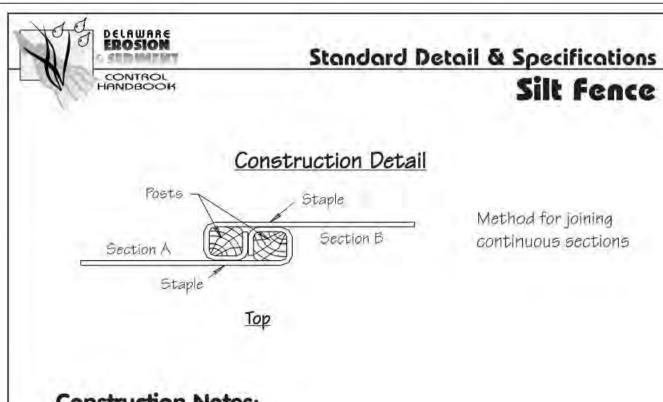

Construction Notes:


- Geosynthetic fabric to be fastened securely to fence posts with wire ties or staples.
- 2. When two sections of filter cloth adjoin each other they shall be overlapped by six inches and folded.
- 3. Maintenance shall be performed as needed and material removed when "bulges" develop in the silt fence.

Materials:

- 1. Stakes: Steel (either T or U) or 2" x 2" hardwood
- Geosynthetic Fabric: Type GD-I
- 3. Reinforcing strip: Wooden lath or plastic strip


Source:	Symbol:	Detail No.
Adapted from		DE-ESC-3.1.2.1
MD Stds. & Specs. for ESC	—— SF ——	Sheet 2 of 2
(mary 2013)	75	Effective FEB 201

Standard Detail & Specifications

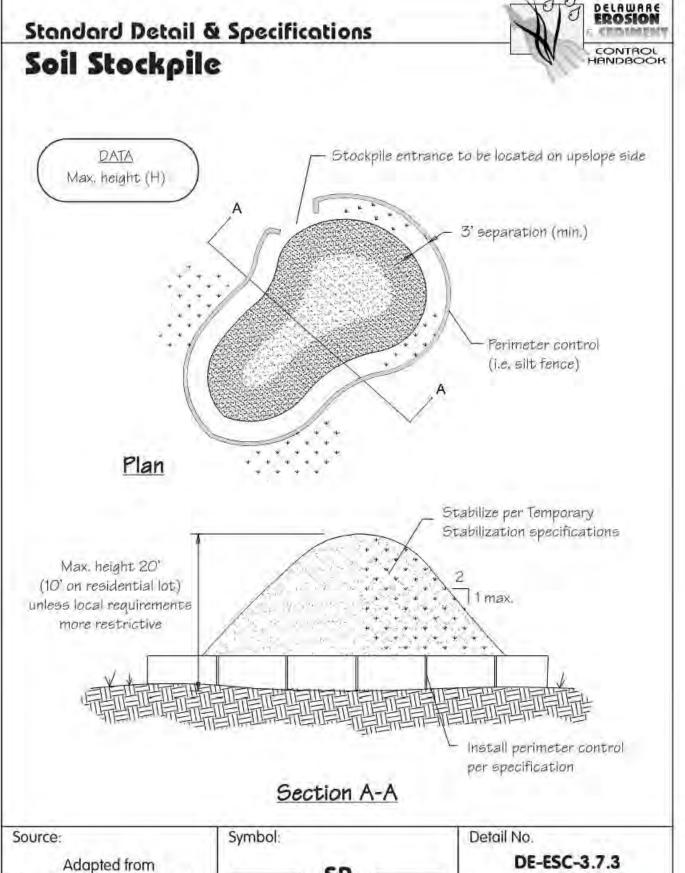

Colorado Urban Storm Drainage

Criteria Manual, Vol 3

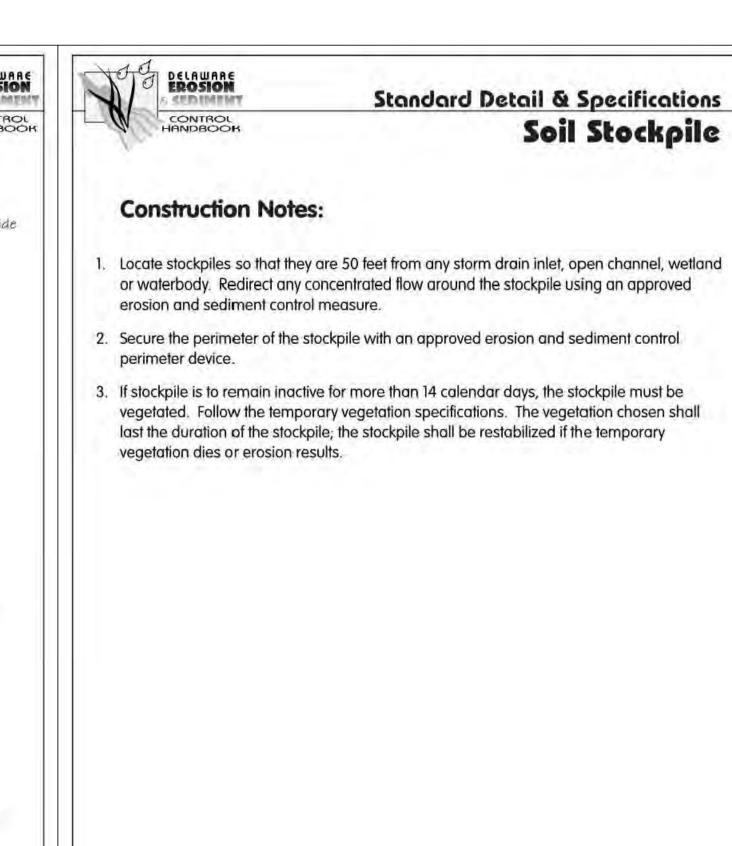


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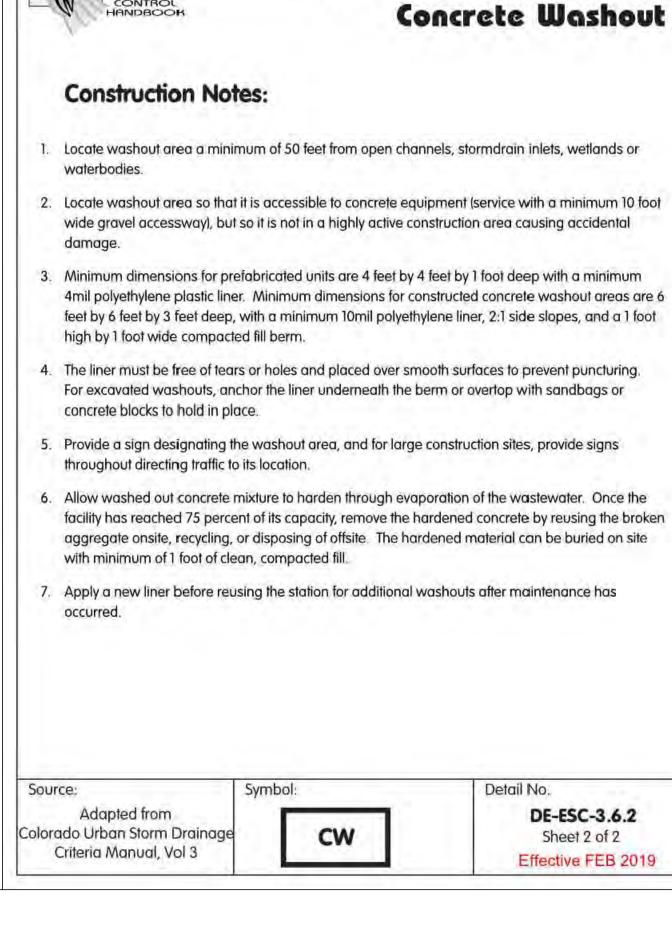
Detail No.


DE-ESC-3.7.3


Sheet 2 of 2

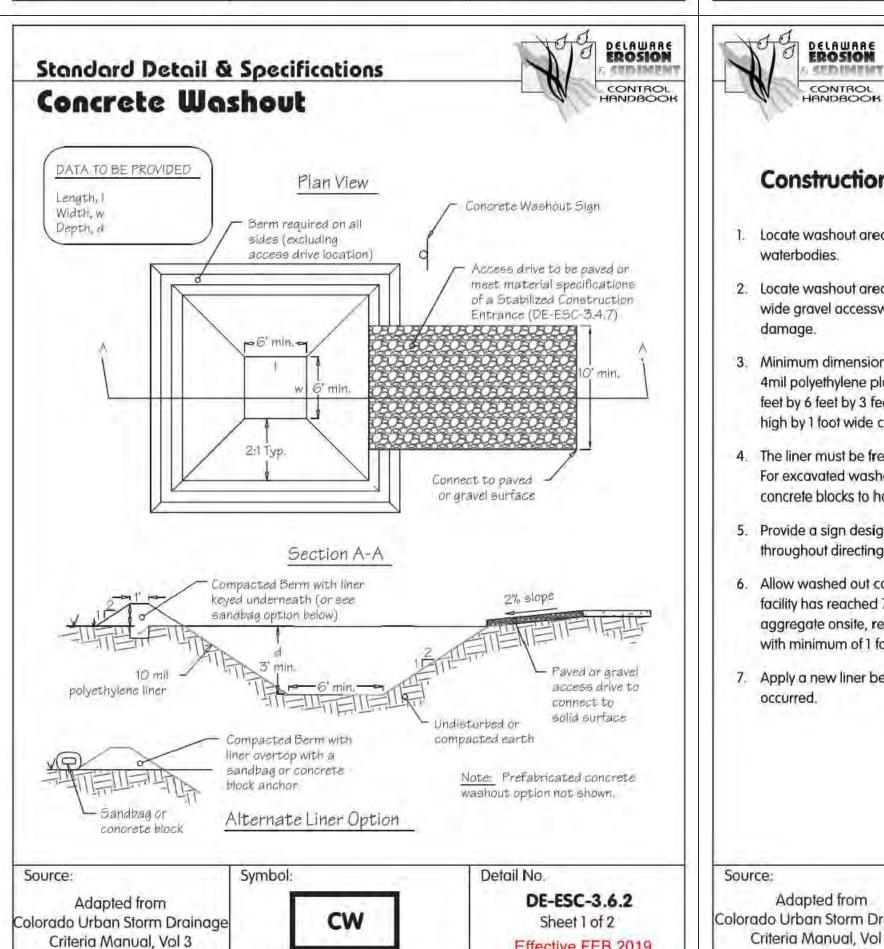

Effective FEB 2019



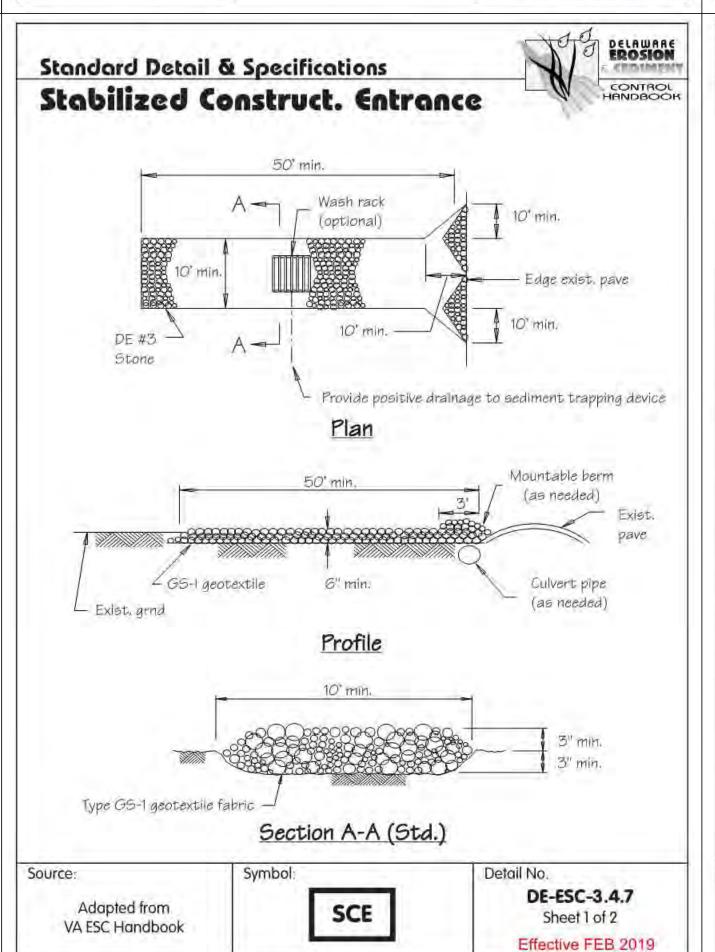

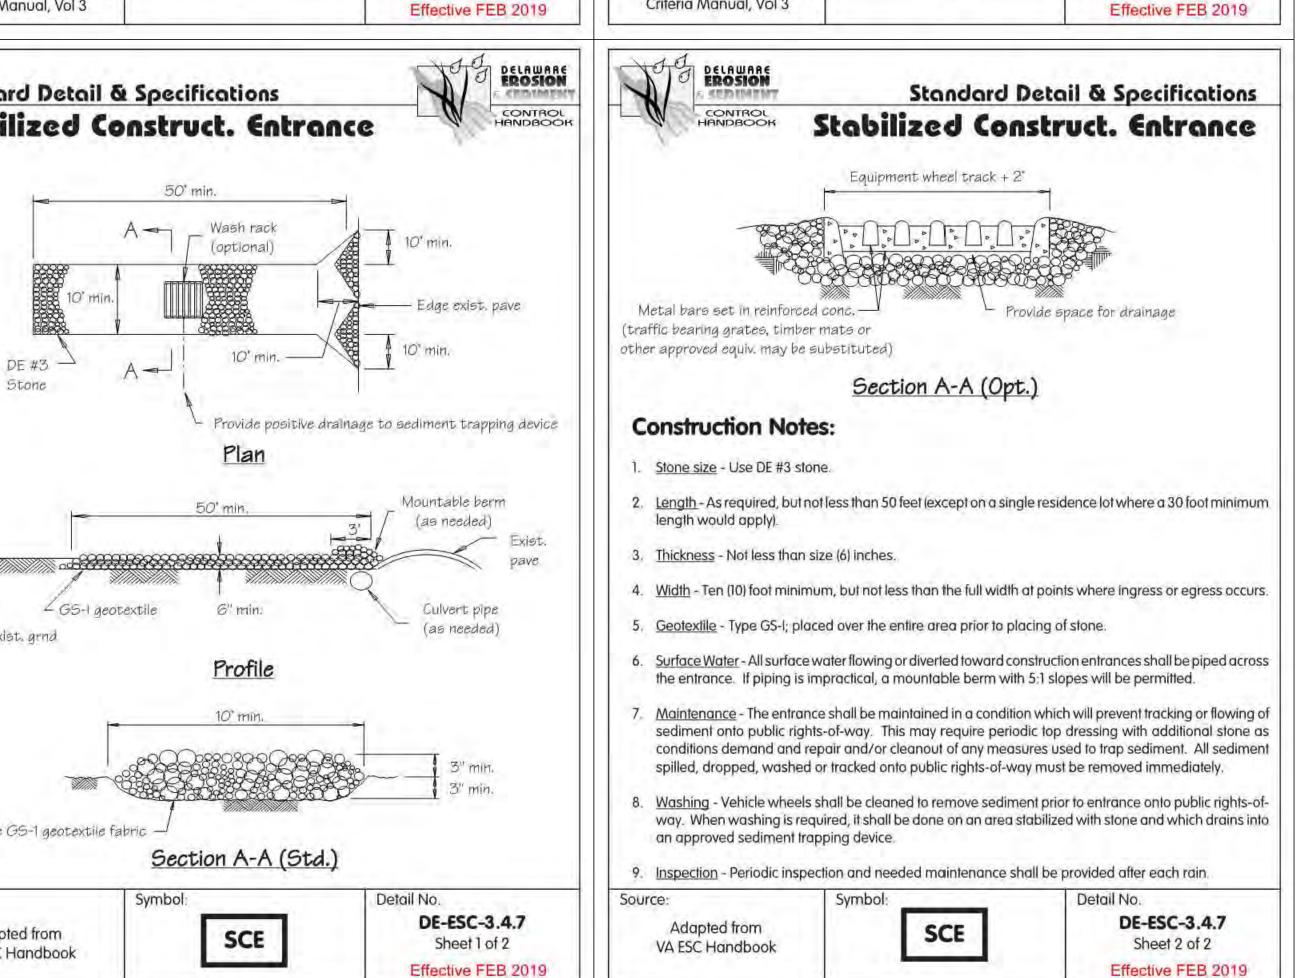

Source:

Sheet 1 of 2

Adapted from


Colorado Urban Storm Drainage

Criteria Manual, Vol 3




DETAILS

EROSION

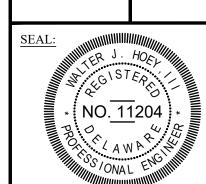

CENTURY ENGINEERING CONSULTING ENGINEERS, SURVEYOR 4134 N. DUPONT HWY.

CEI CONTRACT NO.: 175013.11

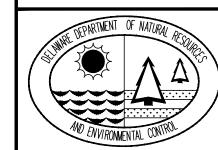

DESIGNED BY:

DRAWN BY:

DFS

CHECKED BY:

AES

AUGUST 2020

SCALE:


NONE

SHEET NO.:

CONTRACT NO.:

2020-KPSP-100

Standard Detail & Specifications Construction Site Waste Mgt & Spill Control ATA TO BE PROVIDED Volume of Potential Height of containment Area of containment Volume of containment

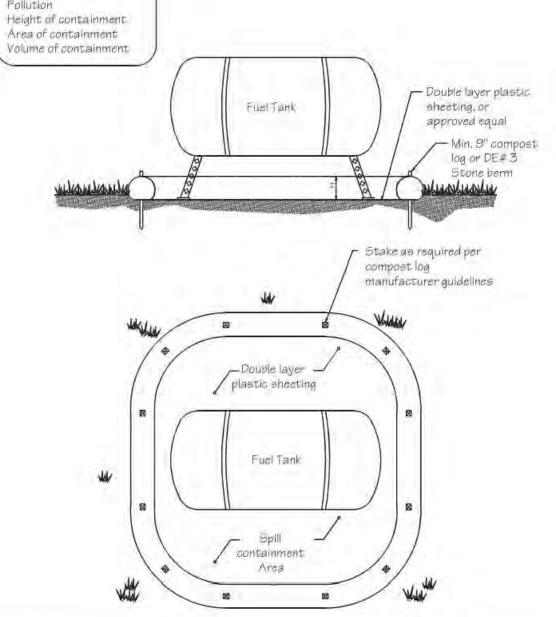

DELAWARE EROSION

CONTROL

DE-ESC-3.6.1

Sheet 1 of 5

DE-ESC-3.6.1

Sheet 5 of 5

Effective FEB 2019

Effective FEB 2019

DELAWARE

Standard Detail & Specifications Construction Site Waste Mgt & Spill Control

Pollution Prevention - Spill Prevention

- Fueling should only take place in signed designated areas, away from downstream drainage facilities and watercourses.
- 2. Fueling must be with nozzles equipped with automatic shut-off to control drips. Do not top off.
- Protect the areas where equipment or vehicles are being repaired, maintained, fueled or parked from storm water run-on and runoff.
- 4. Use barriers such as berms to prevent storm water run-on and runoff, and to contain spills.
- Place a "Fueling Area" sign next to each fueling area.
- 6. Store hazardous materials such as fuel, solvents, oil and chemicals in secondary containment.
- 7. Inspect vehicles and equipment for leaks on each day of use. Repair fluid and oil leaks
- 8. Absorbent spill clean-up materials and spill kits must be available in fueling areas and on fuel
- 9. If fueling is to take place at night, make sure the fueling area is sufficiently illuminated.
- 10. Properly dispose of used oil, fluids, lubricants and spill clean-up materials.
- If it is safe to do so, immediately contain and clean up any chemical and/or hazardous material
- 2. Properly dispose of used oil, fluids, lubricants and spill clean-up materials.
- Do not bury spills or wash them down with water.

LEAKS AND DRIPS

- Use drip pans or absorbent pads at all times. Place under and around leaky equipment.
- 2. Do not allow oil, grease, fuel or chemicals to drip onto the ground.
- Have spill kits and clean up material on-site.
- 4. Repair leaky equipment promptly or remove problem vehicles and equipment from the site. Clean up contaminated soil immediately.
- 5. Store contaminated waste in sealed containers constructed of suitable material. Label these

6. Clean up all spills and le	eaks. Promptly alspose of	waste and spent clean up materials.
Source:	Symbol:	Detail No.
Delaware ESC Handbook		DE-ESC-3.6.1 Sheet 2 of 5
		Effective FEB 2019

Construction Site Waste Mgt &

Notes:

The Construction Site Pollution Prevention Plan should include the following elements:

. Material Inventory

Spill Control

Document the storage and use of the following materials:

Standard Detail & Specifications

- a. Concrete
- b. Detergents c. Paints (enamel and latex)
- d. Cleaning solvents
- e. Pesticides
- Wood scraps
- g. Fertilizers h. Petroleum based products

2. Good housekeeping practices

- a. Store only enough product required to do the job.
- b. All materials shall be stored in a neat, orderly manner in their original labeled containers and covered.
- Substances shall not be mixed.
- d. When possible, all of a product shall be used up prior to disposal of the container.
- e. Manufacturers' instructions for disposal shall be strictly adhered to.
- The site foreman shall designate someone to inspect all BMPs daily.

Waste management practices

- a. All waste materials shall be collected and stored in securely lidded dumpsters in a location that does not drain to a waterbody.
- b. Waste materials shall be salvaged and/or recycled whenever possible.
- c. The dumpsters shall be emptied a minimum of twice per week, or more if necessary. The licensed trash hauler is responsible for cleaning out dumpsters.

Source:	Symbol:	Detail No.
Adapted from USEPA Pub. 840-B-92-002		DE-ESC-3.6.1 Sheet 3 of 5
		Effective FEB 2019



Standard Detail & Specifications Construction Site Waste Mgt &

Spill Control

Notes (cont.)

- d. Trash shall be disposed of in accordance with all applicable Delaware laws.
- e. Trash cans shall be placed at all lunch spots and littering is strictly prohibited. Recycle bins shall be placed near the construction trailer.
- If fertilizer bags can not be stored in a weather-proof location, they shall be kept on a pallet and covered with plastic sheeting which is overlapped and anchored.

4. Equipment maintenance practices

- a. If possible, equipment should be taken to off-site commercial facilities for washing and
- b. If performed on-site, vehicles shall be washed with high-pressure water spray without detergents in an area contained by an impervious berm.
- c. Drip pans shall be used for all equipment maintenance.
- d. Equipment shall be inspected for leaks on a daily basis.
- e. Washout from concrete trucks shall be disposed of in a temporary pit for hardening and proper disposal.
- Fuel nozzles shall be equipped with automatic shut-off valves.
- g. All used products such as oil, antifreeze, solvents and tires shall be disposed of in accordance with manufacturers' recommendations and local, state and federal laws and

5. Spill prevention practices

- a. Potential spill areas shall be identified and contained in covered areas with no connection to the storm drain system.
- b. Warning signs shall be posted in hazardous material storage areas.
- c. Preventive maintenance shall be performed on all tanks, valves, pumps, pipes and other equipment as necessary.

Low or non-toxic substances shall be prioritized for use.

Source:	Symbol:	Detail No.
Adapted from USEPA Pub. 840-B-92-002		DE-ESC-3.6.1
FUD. 040-D-72-002		Sheet 4 of 5
		Effective FEB 2019

Standard Detail & Specifications Construction Site Waste Mgt &

Symbol:

Spill Control

Notes (cont.)

Delaware ESC Handbook

e. Contact information for reporting spills through the DNREC 24-Hour Toll Free Number shall be prominently posted.

6. Education

Source:

- a. Best management practices for construction site pollution control shall be a part of regular progress meetings.
- Information regarding waste management, equipment maintenance and spill prevention shall be prominently posted in the construction trailer.

CONTACT INFORMATION

DNREC 24-Hour Toll Free Number 800-662-8802 **DNREC Solid & Hazardous Waste Management Section** 302-739-9403

Symbol:

Adapted from USEPA

Pub. 840-B-92-002

Standard Detail & Specifications Topsoiling



Construction Notes:

1. Site Preparation (Where Topsoil is to be added)

Note: When topsoiling, maintain needed erosion and sediment control practices such as diversions, grade stabilization structures, berms, dikes, waterways and sediment basins.

- a. Grading Grades on the areas to be topsoiled which have been previously established
- b. Liming Where the topsoil is either highly acid or composed of heavy clays, ground limestone shall be spread at the rate of 4-8 tons/acre (200-400 pounds per 1,000 square feet). Lime shall be distributed uniformly over designated areas and worked into the soil in conjunction with tillage operations as described in the following procedures.
- Tilling After the areas to be topsoiled have been brought to grade, and immediately prior to dumping and spreading the topsoil, the subgrade shall be loosened by discing or by scarifying to a depth of a least 3 inches to permit bonding of the topsoil to the subsoil. Pack by passing a bulldozer up and down over the entire surface area of the slope to create horizontal erosion check slots to prevent topsoil from sliding down the slope.

2. Topsoil Material and Application

Note: Topsoil salvaged from the existing site may often be used but it should meet the same standards as set forth in these specifications. The depth of topsoil to be salvaged shall be no more than the depth described as a representative profile for that particular soil type as described in the soil survey published by USDA-SCS in cooperation with Delaware Agricultural Experimental Station.

ource:	Symbol:	Detail No.
		DE-ESC-3.4.1
USDA - NRCS		Sheet 1 of 2 Effective FEB 2019



Construction Notes (cont.)

a. Materials - Topsoil shall be a loam, sandy loam, clay loam, silt loam, sandy clay loam, loamy sand or other soil as approved by an agronomist or soil scientist. It shall not have a mixture of contrasting textured subsoil and contain no more than 5 percent by volume of cinders, stones, slag, coarse fragment, gravel, sticks, roots, trash or other extraneous materials larger than 1-1/2 inches in diameter. Topsoil must be free of plants or plant parts of bermudagrass, quackgrass, Johnsongrass, nutsedge, poison ivy, thistles, or others as specified. All topsoil shall be tested by a reputable laboratory for organic matter content, pH and soluble salts. A pH of 6.0 to 7.5 and an organic content of not less than 1.5 percent by weight is required. If pH value is less than 6.0 lime shall be applied and incorporated with the topsoil to adjust the pH to 6.5 or higher. Topsoil containing soluble salts greater than 500 parts per million shall not be used.

Standard Detail & Specifications

Topsoiling


Note: No sod or seed shall be placed on soil which has been treated with soil sterilants or chemicals used for weed control until sufficient time has elapsed to permit dissipation of toxic materials.

 Grading - The topsoil shall be uniformly distributed and compacted to a minimum of four (4) inches. Spreading shall be performed in such a manner that sodding or seeding can proceed with a minimum of additional soil preparation and tillage. Any irregularities in the surface resulting from topsoiling or other operations shall be corrected in order to prevent the formation of depressions or water pockets. Topsoil shall not be placed while in a frozen or muddy condition, when the subgrade is excessively wet, or in a condition that may otherwise be detrimental to proper grading and seedbed preparation.

Note: Topsoil substitutes or amendments as approved by a qualified agronomist or soil scientist, may be used in lieu of natural topsoil. Compost material used to improve the percentage of organic matter shall be provided by a certified supplier.

Compost amendments that are intended to meet specific post-construction stormwater management goals shall further meet the requirements of Appendix 3.06.2 Post Construction Stormwater Management BMP Standards and Specifications, Section 14.0 Soil Amendments.

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		DE-ESC-3.4.1
USDA - NRCS		Sheet 2 of 2
		Effective FEB 2019

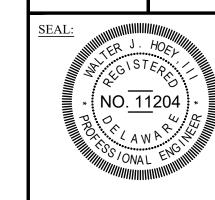

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DATE: DESCR

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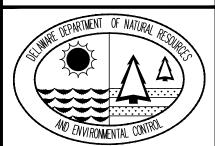
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CIVIL ENGINEER:

CENTURY ENGINEERING CONSULTING ENGINEERS, SURVEYOR 4134 N. DUPONT HWY. DOVER, DELAWARE 19901

CEI CONTRACT NO.: 175013.11



DESIGNED BY:

DRAWN BY:

CHECKED BY:

AUGUST 2020

SCALE: NONE

SHEET NO.: SSMP503

CONTRACT NO.: 2020-KPSP-100

Standard Detail & Specifications Mulching



. Materials and Amounts

- a. Straw Straw shall be unrotted small grain straw applied at the rate of 1-1/2 to 2 tons per acre, or 70 to 90 pounds (two bales) per 1,000 square feet. Mulch materials shall be relatively free of weeds and shall be free of noxious weeds such as; thistles, Johnsongrass, and quackgrass. Spread mulch uniformly by hand or mechanically. For uniform distribution of hand spread mulch, divide area into approximately 1,000 square feet sections and place 70-90 pounds (two bales) of mulch in each section.
- b. Wood chips Apply at the rate of approximately 6 tons per acre or 275 pounds per 1,000 square feet when available and when feasible. These are particularly well suited for utility and road rights-of-way. If wood chips are used, increase the application rate of nitrogen fertilizer by 20 pounds of N per acre (200 pounds of 10-10-10 or 66 pounds of 30-0-0 per acre).
- c. Hydraulically applied mulch-The following conditions apply to hydraulically applied mulch:

- a. Wood fiber mulch shall consist of specially prepared wood that has been processed to a uniform state, is packaged for sale as a hydraulic mulch for use with hydraulic seeding equipment, and consists of a minimum of 70% virgin or recycled wood fiber combined with 30% paper fiber and additives.
- b. Blended fiber mulch shall consist of any hydraulic mulch that contains greater than 30% paper fiber. The paper component must consist of specially prepared paper that has been processed to a uniform fibrous state and is packaged for sale as a hydraulic mulch for use with hydraulic seeding equipment.
- c. A bonded fiber matrix (BFM) consists of long strand, specially prepared wood fibers that have been processed to a uniform state held together by a water resistant bonding agent. BFMs shall contain no paper (cellulose) mulch but may contain small percentages of synthetic fibers to enhance performance.
- Refer to Figure 3.4.5a for conditions and limitations of use for each of the above categories of
- ii. All components of the hydraulically applied mulches shall be pre-packaged by the manufacturer to assure material performance. Field mixing of the mulch components is acceptable, but must be done per manufacturers recommendations to ensure the proper results.
- Hydraulic mulches shall be applied with a viable seed and at manufacturer's recommended rates. Increased rates may be necessary based on site conditions.
- iv. Hydraulically applied mulches and additives shall be mixed according to manufacturers
- iv. Materials within this category shall only be used when hydraulically applied mulch has been specified for use on the approved Sediment and Stormwater Plan, or supplemental approval from the plan approval agency has been obtained in writing for a specific area.

Source:	Symbol:	Detail No.
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Delaware ESC Handbook & Filtrexx TM International		Sheet 1 of 3
& Fillrexxinternational		Effective FEB 2019


Standard Detail & Specifications

Mulching

- - a. Apply product to geotechnically stable slopes that have been designed and constructed to divert runoff away from the face of the slope.
 - b. Do not apply to saturated soils, or if precipitation is anticipated within 24-48 hours. c. During the spring (March 1 to May 31) and fall (September 1 to November 30) seasons, hydraulic
- mulches may be applied in a one-step process where all components are mixed together in single-tank loads. It is recommended that the product be applied from opposing directions to achieve optimum soil coverage.
- d. During the summer (June 1 to August 31) and winter (December 1 to February 28) seasons, the following two-step process is required:
 - Step One- Mix and apply seed and soil amendments with a small amount of mulch for
- Step Two Mix and apply mulch at manufacturers recommended rates over freshly
- seeded surfaces. Apply from opposing directions to achieve optimum soil coverage. e. Minimum curing temperature is 40° F (4° C). The best results and more rapid curing are achieved at temperatures exceeding 60°F (15°C). Curing times may be accelerated in high temperature, low humidity conditions on dry soils.
- vi. Recommended application rates are for informational purposes only. Conformance with this standard and specification shall be performance-based and requires 100% soil coverage. Any areas with bare soil showing shall be top dressed until full coverage is achieved.
- d. Compost blanket (CB) Loosely applied with a pneumatic blower so that a 1" compost blanket uniformly covers the soil with 100% coverage. This application can be used with seed to promote germination by applying the approved seed mix directly into the loosely blown compost. The compost blanket performs best on slopes less than 2:1 and requires no mulch anchoring.
- Anchoring mulch Mulch must be anchored immediately to minimize loss by wind or water. This may be done by one of the following methods, depending upon size of area, erosion hazard, and cost.
- a. Crimping A crimper is a tractor drawn implement designed to punch and anchor mulch into the top two (2) inches of soil. This practice affords maximum erosion control but is limited to flatter slopes where equipment can operate safely. On sloping land, crimping should be done on the contour whenever possible.
- Tracking Tracking is the process of cutting mulch (usually straw) into the soil using a bulldozer or other equipment that runs on cleated tracks. Tracking is used primarily on slopes 3:1 or steeper and should be done up and down the slope with cleat marks running across the slope.
- c. Liquid mulch binders Applications of liquid mulch binders should be heavier at edges, in valleys, and at crests of banks and other areas where the mulch will be moved by wind or water. All other areas should have a uniform application of binder. The use of synthetic binders is the preferred method of mulch binding and should be applied at the rates recommended by the manufacturer.
- d. Paper fiber The fiber binder shall be applied at a net dry weight of 750 lbs/ac. The wood cellulose fiber shall be mixed with water, and the mixture shall contain a maximum of 50 lbs. of wood cellulose fiber per
- e. Nettings Synthetic or organic nettings may be used to secure straw mulch. Install and secure according to the manufacturers recommendations.

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Delaware ESC Handbook & Filtrexx TM International		Sheet 2 of 3
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Standard Detail & Specifications Mulching

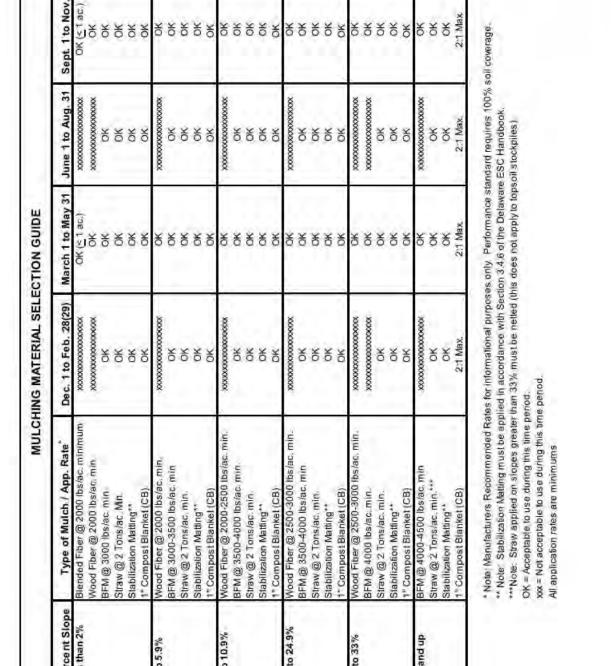

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Delaware ESC Handbook & Filtrexx TM International			Sheet 3 of 3
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Standard Detail & Specifications Vegetative Stabilization

EROSION

CONTROL



Effective FEB 2019

Mix#	Mix#	Species ⁶	Seeding Rate		O = Op			m Seed erlod, A =			ling Period	Planting Depth
			= .	Co	astal P	lain	P	edmo	nt	All	J	
	Certified Seed lb/Ac 5	Ac 5 (b/1000 sq.ft.	2/1- 4/30	² 5/1- B/14	8/15- 10/31	3/1-4/30	² 5/1-7/31	8/1- 10/31	10/31- 2/1			
1	Barley	125	4	0	Α	0	0	Α	0		1-2 inches 2-3" sandy soils	
2	Oats	125	4	0	Α	A	0	Α	A	(J.E.)	1-2 inches 2-3" sandy soils	
3	Rye	125	4	0	Α	0	0	Α	0	Α	1-2 inches 2-3" sandy soils	
4	Perennial Ryegrass	125	4	0	A	0	0	A	0		0.5 inches 1-2" sandy soils	
5	Annual Ryegrass	125	4	0	Α	0	0	Α	0	A	0.5 inches 1-2" sandy soils	
6	Winter Wheat	125	4	0	Α	0	0	Α	0	A	1-2 inches 2-3" sandy soils	
7	Foxtail Millet	30 PLS	0.7		0		- T	0		L T	0.5 inches 1-2" sandy soils	
8	Pearl Millet	20 PLS	0.5		0			0			0.5 inches 1-2" sandy soils	

- 1. Winter seeding requires 3 tons per acre of straw mulch for proper stabilization.
- 2. May be planted throughout summer if soil moisture is adequate or seeded area can be irrigated.
- Applicable on slopes 3:1 or less.
- 4. Fifty pounds per acre of Annual Lespedeza may be added to 1/2 the seeding rate of any of the above species. 5. Use varieties currently recommended for Delaware. Contact a County Extension Office for Information.
- 6. Warm season grasses such as Millet or Weeping Lovegrass may be used between 5/1 and 9/1 if desired. Seed at 3-5 lbs.
- per acre. Good on low fertility and acid areas. Seed after frost through summer at a depth of 0.5".

NOTE: Alternative seed mixes may be used with prior approval from the Department or Delegated Agency.

ource:	Symbol:	Detail No.
Delaware ESC Handbook		DE-ESC-3.4.3
		Sheet 1 of 4

CERSMENT CONTROL

Standard Detail & Specifications Vegetative Stabilization


Seeding Mixtures		Seedin	g Rate	Optimum Seeding Dates ² Q = Optimum Planting Period A = Acceptable Planting Period							Remarks
Mix No.	Certified Seed			Coastal Plain Piedmont					All*		
	Well Drained Soils	lb/Ac	lb/1000 sq.ft.	2/1- 4/30	5/1- 8/14	8/15-	3/1- 4/30	5/1- 7/31	8/1- 10/31	10/31-2/1	
1	Tall Fescue Weeping Lovegrass	140	3,2 0.23	Α	0	A	A	Ó	A	Add 100 lbs./ac Winter Rye	Good erosion control mix Tolerant of low fertility soils Lovegrass very difficult to mow Germinates only in hot weather
2	Deertongue Sheap Fescue Common Lespedeza ⁵ Inoculated	30 30 15	0.69 0.69 0.35	A	0	Α	A	0	A	Add 100 lbs./ac Winter Rye	Good erosion control mix Tolerant of low fertility soils Good wildlife cover and food
3	Tall Fesque (Turf-type) or Strong Creeping Red Fescue or Perennial Ryagrass plus Flatpea ⁸	50 50 50	1.15 1.15 1.15	0	A	0	0	A	0	Add 100 lbs./ac. Winter Rye	Good erosion control mix Tall Fescue for droughty conditions. Creeping Red. Fescue for heavy shade. Flatpea to suppress woody vegetation.
4	Strong Creeping Red Fescue Kentucky Bluegrass Perannial Ryegrass or Redtop plus White Clover ³	100 70 15 5	2.3 1.61 0.35 0.11	0	A	0	0	A	0	Add 100 lbs./ac. Winter Rye	Suitable waterway mix. Cenada Bluegrass more drought tolerant. Use Redtop for increased drought tolerance.
5	Switchgrass ^{n/} or Coastal Panicgrass Big Bluestern Little Bluestern Indian Grass	10 10 5 5	0.23 0.23 0.11 0.11 0.1		0			0			Native warm-season mixture Tolerant of low fertility soils. Drought tolerant Poor shade tolerance. N fertilizer discouraged - weeds
-6	Tall Fescue (turf-type) (Blend of 3 cultivars)	150	3.5	0	Α	0.	0	Α	0		Managed filter strip for nutrient uptake.
7	Tall Fescue Ky. Bluegrass (Blend) Perennial Ryegrass	150 20 20	3.5 0.46 0.46	0	A	0	0	Α	0		Three cultivars of Kentucky Bluegrass, Traffic (olerant,
8	Big Bluestem/ Indian Grass ⁷ Little Bluestem ⁷ Creeping Red Fescue plus one of: Partridge Pea Bush Clover Wild Indigo Showy Tick-Trefoil	10 10 8 30 5 3	0.23 0.23 0.18 0.69 0.11 0.07 0.07	O	A		Ö	Α			All species are native Indian Grass and Bluestern have fluffy seeds. Plant with a specialized native seed drill. Creeping Red Fescue will provide prosion protection while the warm season grasses get established.

NOTE: Alternative seed mixes may be used with prior approval from the Department or Delegated Agency.

Source: Symbol:		Detail No.
Delaware ESC Handbook		DE-ESC-3.4.3 Sheet 2 of 4 Effective FEB 2019

Standard Detail & Specifications Vegetative Stabilization

Creeping Red Fescu Rough Bluegrass or

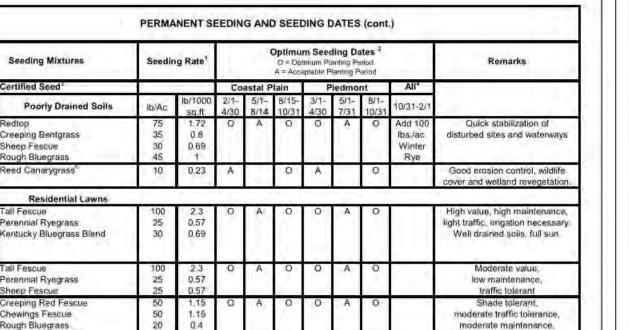

 When hydroseeding is the chosen method of application, the total rate of seed should be increased by 25% 2. Winter seeding requires 3 tons per acre of straw mulch. Planting dates listed above are average for Delaware. These dates may require adjustment to 3. All seed shall meet the minimum purity and minimum germination percentages recommended by the Delaware Department of Agriculture. The maximum % of weed seeds shall be in accordance with Section 1, Chapter 24, Title 3 of the Delaware Code.

4. Cool season species may be planted throughout summer if soil moisture is adequate or seeded area can be irrigated 5. All leguminous seed must be inoculated.

B. Warm season grass mix and Reed Canary Grass cannot be moved more than 4 times per year. 7. Warm season grasses require a soil temperature of at least 50 degrees in order to germinate, and will remain dormant until then.

NOTE: Alternative seed mixes may be used with prior approval from the Department or Delegated Agency.

Source:	Symbol:	Detail No.
Delaware ESC Handbook		DE-ESC-3,4.3
		Sheet 3 of 4
		Effective FEB 2019

CEDIMENT

CONTROL

moisture tolerant.

Standard Detail & Specifications Vegetative Stabilization

Construction Notes:

- Site Preparation
- a. Prior to seeding, install needed erosion and sediment control practices such as diversions, grade stabilization structures, berms, dikes, grassed waterways, and sediment basins.
- Final grading and shaping is not necessary for temporary seedings.
- Seedbed Preparation


It is important to prepare a good seedbed to insure the success of establishing vegetation. The seedbed should be well prepared, loose, uniform, and free of large clods, rocks, and other objectionable material. The soil surface should not be compacted or crusted.

Soil Amendments

- a. Lime Apply liming materials based on the recommendations of a soil test in accordance with the approved nutrient management plan. If a nutrient management plan is not required, apply dolomitic limestone at the rate of 1 to 2 tons per acre. Apply limestone uniformly and incorporate into the top 4 to 6 inches of soil.
- b. Fertilizer Apply fertilizer based on the recommendations of a soil test in accordance with the approved nutrient management plan. If a nutrient management plan is not required, apply a formulation of 10-10-10 at the rate of 600 pounds per acre. Apply fertilizer uniformly and incorporate into the top 4 to 6 inches of soils.
- a. For temporary stabilization, select a mixture from Sheet 1. For a permanent stabilization, select a mixture from **Sheet 2** or **Sheet 3** depending on the conditions. Alternative seed mixes may be used with prior approval from the Department or Delegated Agency.
- b. Apply seed uniformly with a broadcast seeder, drill, cultipacker seeder or hydroseeder. All seed will be applied at the recommended rate and planting depth.
- Seed that has been broadcast should be covered by raking or dragging and then <u>lightly</u> tamped into place using a roller or cultipacker. If hydroseeding is used and the seed and fertilizer is mixed, they will be mixed on site and the seeding shall be done immediately and without interruption.
- 5. Mulching

All mulching shall be done in accordance with detail DE-ESC-3.4.5.

Source:	Symbol:	Detail No.
Delaware ESC Handbook		DE-ESC-3.4.3
		Sheet 4 of 4
		Effective FEB 2019

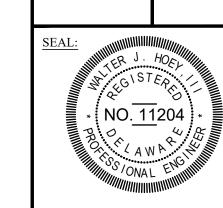

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CIVIL ENGINEER:

CENTURY ENGINEERING CONSULTING ENGINEERS, SURVEYORS 4134 N. DUPONT HWY. DOVER, DELAWARE 19901



DESIGNED BY:

DRAWN BY:

CHECKED BY:

AUGUST 2020

SCALE: NONE

SSMP504

CONTRACT NO.: 2020-KPSP-100



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S-31	STRUCTURAL COMPONENT DETAILS	



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	IVO.	DATE DESCRIPTION	
1 03/19/2020 REVISED DRAFT		REVISED DRAFT	
2 03/24/2020 REVISED DRAFT #2		REVISED DRAFT #2	
3 04/01/2020 REVISED DRAFT #3		REVISED DRAFT #3	
	4	4 04/15/2020 12-IN ALUM. DECK PLAN	
	5 05/29/2020 STAMPED SUBMITTAL		STAMPED SUBMITTAL

PROJECT NAME:

DNREC KILLENS POND PEDESTRIAN BRIDGE

CUSTOMER NAME:

DELAWARE DIVISION OF PARKS & RECREATION

CUSTOMER ADDRESS:

89 KINGS HIGHWAY DOVER, DELAWARE 19901

PROJECT LOCATION:

5025 KILLENS POND ROAD FELTON, DE 19943

Q98254

CUSTOMER PO NO .:

	NAME	DATE
DRAWN BY:	KLC	05/22/2020
CHECKED BY:	MKL	05/29/2020
FABRICATION:	BRS	05/29/2020

DRAWING NO.:

TITLE PAGE TABLE OF CONTENTS

TOLERANCES UNLESS SPECIFIED OTHERWISE XXX = ± 1/4"; FRACTIONS = ± 1/8"; ANGULAR = ± 1°

CMI LIMITED CO.

605 MOLLY LANE - SUITE 150 WOODSTOCK, GA 30189 PHONE: 770-933-8166 COA #4043



GENERAL NOTES:

ALUMINUM SPECIFICATIONS:

- ALL STRUCTURAL COMPONENTS SHALL BE 6061-T6 ALUMINUM
- ALL NON-STRUCTURAL COMPONENTS MAY BE 6063-T6 ALUMINUM
- ALL ALUMINUM WELD FILLER SHALL BE 5356
- ALUMINUM WELDING SHALL CONFORM TO AWS D1.2

FINISH:

- BRIDGE SHALL BE ALUMINUM MILL FINISH

BEARING COMPONENTS:

- BEARING PADS TO BE UHMW

CAMBER NOTES:

- NO BRIDGE CAMBER REQUIRED

INSTALLATION:

- INSTALLATION BY OTHERS NO RESPONSIBILITY IS ACCEPTED FOR WORK BY OTHERS
- BRIDGES ARE SIZED FOR 1" ANCHOR BOLTS, TO BE DESIGNED AND PROVIDED BY OTHERS.
- BRIDGES ARE SIZED FOR A 1" ± GAP ON EACH END (2" BETWEEN SPANS).

LOADING


 SEE CALCULATION PACKAGE FOR COMPLETE DESIGN & LOADING CRITERIA LIVE LOAD: 90 PSF VEHICLE LOAD: ONE @ 2,500 LB WIND LOAD: 97 MPH PER AASHTO STANDARD SPECIFICATIONS / ASCE 7-05 NO FLOOD LOADING CONSIDERED

DESIGN CRITERIA:

- AASHTO LRFD GUIDE SPECIFICATIONS FOR THE DESIGN OF PEDESTRIAN BRIDGES, 2009 WITH 2015 INTERIM REVISIONS
- AASHTO LRFD BRIDGE DESIGN SPECIFICATIONS, 2010 WITH 2016 INTERIM REVISIONS
- AASHTO STANDARD SPECIFICATIONS FOR STRUCTURAL SUPPORTS FOR HIGHWAY SIGNS, LUMINAIRES, AND TRAFFIC SIGNALS, 2013 WITH 2015 INTERIM REVISIONS
- NATIONAL ASSOCIATION OF ARCHITECTURAL METAL MANUFACTURERS (NAAMM) PIPE RAILING SYSTEMS MANUAL (AMP 521-01 (R2012))
- STANDARD ENGINEERING PRACTICE

FABRICATION NOTES:

- DEBURR ALL EXPOSED WELDS WHICH MAY COME IN CONTACT WITH PEDESTRIANS.
- ADD WEEP HOLESAS NEEDED.

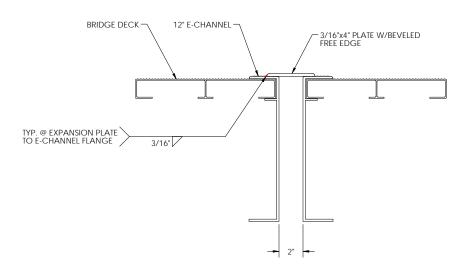

EXPANSION JOINT COVER: ELEVATION VIEW



EXPANSION JOINT COVER: ISO VIEW CUT SECTION



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RECORD OF REVISIONS

No.	DATE	DESCRIPTION
1 03/19/2020 REVISED DRAFT		REVISED DRAFT
2	03/24/2020	REVISED DRAFT #2
3	04/01/2020	REVISED DRAFT #3
4	04/15/2020	12-IN ALUM. DECK PLANKS
5	05/29/2020	STAMPED SUBMITTAL

PROJECT NAME:

DNREC KILLENS POND PEDESTRIAN BRIDGE

CUSTOMER NAME:

DELAWARE DIVISION OF PARKS & RECREATION

CUSTOMER ADDRESS:

89 KINGS HIGHWAY DOVER, DELAWARE 19901

PROJECT LOCATION:

5025 KILLENS POND ROAD FELTON, DE 19943

CMI ORDER NO.:

Q98254

CUSTOMER PO NO.

	NAME	DATE
DRAWN BY:	KLC	05/22/2020
CHECKED BY:	MKL	05/29/2020
FABRICATION:	BRS	05/29/2020

DRAWING NO.:

S-2
BRIDGE
GENERAL NOTES

Physical properties are defined by ASTM testing standards. The Aluminum Association Design Manual. The Manual Recitation Design Manual Design 2 and the Lawny Copie of Testing States and Copie PC-Steet Fig. 1 and 1 an

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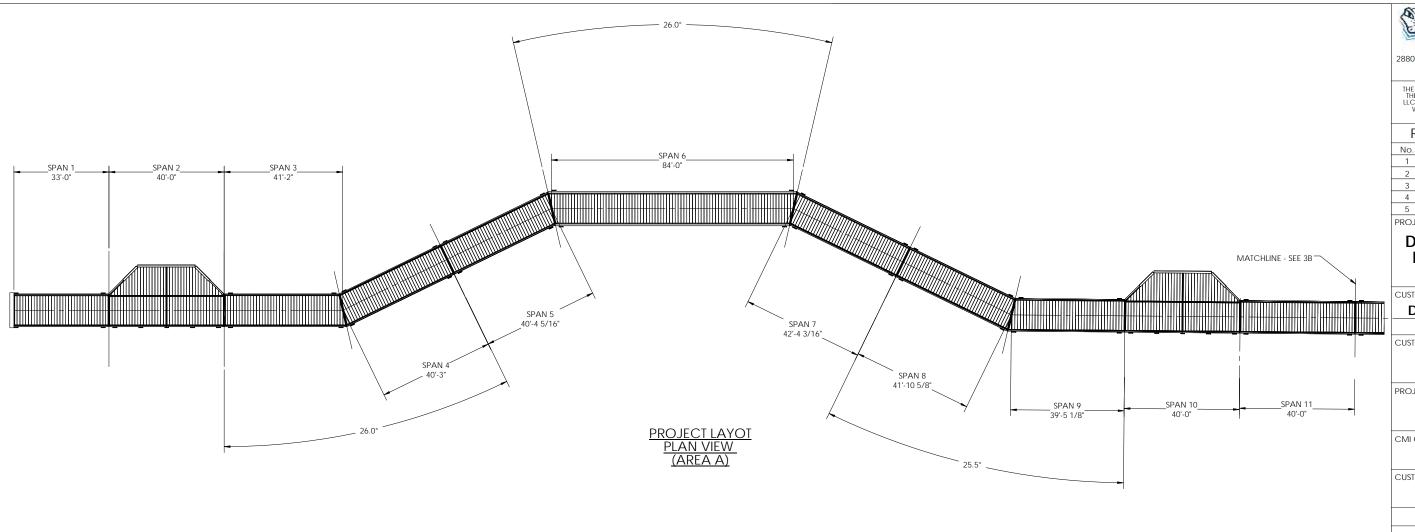
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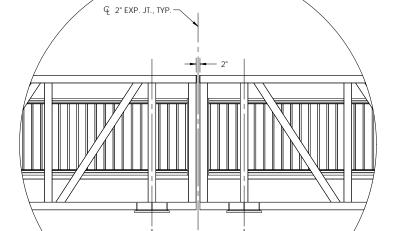


CUSTOMER INITIAL

> BRENDAN R. SHEPPARD DELAWARE PE #14366

PROFESSIONAL CERTIFICATION. I HEREBY CERTIFY THAT THESE DOCUMENTS WERE PREPARED OR APPROVED BY ME, AND THAT I AM A DULY LICENSED PROFESSIONAL ENGINEER UNDER THE LAWS OF THE STATE OF DELAWARE, LICENSE NO. 14366.





TYPICAL EXPANSION JOINT

NOTES:

- 1. INTERIOR SPANS: DIMENSIONS ARE MEASURED $\mbox{\ensuremath{\mathbb{Q}}}$ -TO- $\mbox{\ensuremath{\mathbb{Q}}}$ OF EXPANSION JOINT.
- 2. END SPANS: DIMENSIONS ARE MEASURED FACE OF BACKWALL-TO-Q OF EXPANSION JOINT.
- 3. SPANS 1 AND 20 HAVE ROTATED BASE PLATES TO ACCOMODATE ELEVATION CHANGE.
- 4. SPAN 2: CONTRACTOR TO SHIM AS NEEDED TO ACCOMODATE ELEVATION CHANGE.



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5	05/29/2020	STAMPED SUBMITTAL

PROJECT NAME:

DNREC KILLENS POND PEDESTRIAN BRIDGE

CUSTOMER NAME:

DELAWARE DIVISION OF PARKS & RECREATION

CUSTOMER ADDRESS:

89 KINGS HIGHWAY DOVER, DELAWARE 19901

PROJECT LOCATION:

5025 KILLENS POND ROAD FELTON, DE 19943

CMI ORDER NO.:

Q98254

CUSTOMER PO NO .:

	NAME	DATE
DRAWN BY:	KLC	05/26/2020
CHECKED BY:	MKL	05/29/2020
FABRICATION:	BRS	05/29/2020

DRAWING NO.:

S-3A

PROJECT LAYOUT (AREA A)


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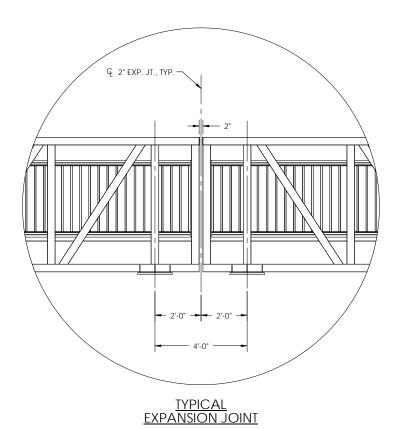
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CUSTOMER INITIAL



PROJECT LAYOT PLAN VIEW (AREA B)



NOTES:

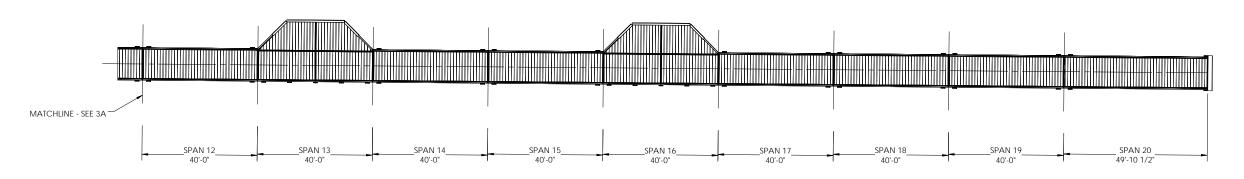- 1. INTERIOR SPANS: DIMENSIONS ARE MEASURED Q -TO-Q OF EXPANSION JOINT.
- 2. END SPANS: DIMENSIONS ARE MEASURED FACE OF BACKWALL-TO-Q OF EXPANSION JOINT.
- 3. SPANS 1 AND 20 HAVE ROTATED BASE PLATES TO ACCOMODATE ELEVATION CHANGE.
- 4. SPAN 2: CONTRACTOR TO SHIM AS NEEDED TO ACCOMODATE ELEVATION CHANGE.



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	4	04/15/2020	12-IN ALUM. DECK PLANK
	5	05/29/2020	STAMPED SUBMITTAL

PROJECT NAME:

DNREC KILLENS POND PEDESTRIAN BRIDGE

CUSTOMER NAME:

DELAWARE DIVISION OF PARKS & RECREATION

CUSTOMER ADDRESS:

89 KINGS HIGHWAY DOVER, DELAWARE 19901

PROJECT LOCATION:

5025 KILLENS POND ROAD FELTON, DE 19943

CMI ORDER NO.:

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CUSTOMER PO NO .:

	NAME	DATE
DRAWN BY:	KLC	05/26/2020
CHECKED BY:	MKL	05/29/2020
FABRICATION:	BRS	05/29/2020

DRAWING NO.:

S-3B

PROJECT LAYOUT (AREA B)

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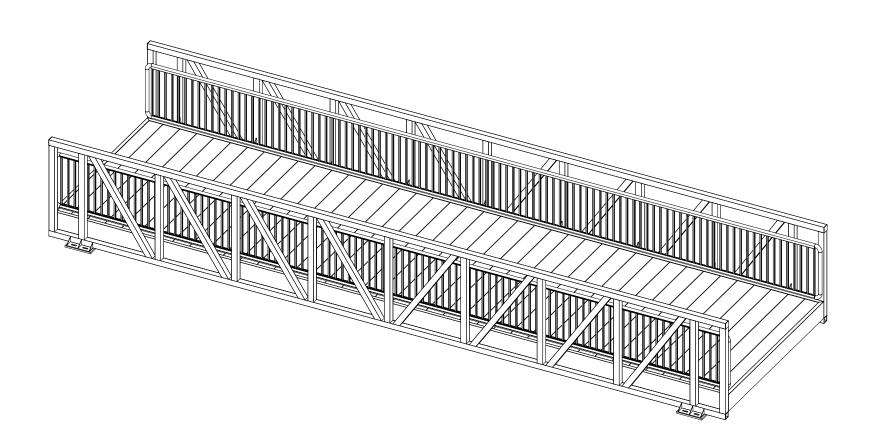
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		BILL OF MATERIALS		
ITEM # TYPE DESCRIPTION		DESCRIPTION	QTY/COMMENTS WEIG	
PAN 11,12, 4,15,17,18, AND 19		10'x39'-10" CASCADE BRIDGE	0'-10" CASCADE BRIDGE 7 ~5,200	
1	BOX FRAME	12" E-CHANNEL	1	
2	TRUSS CHORDS	4"x4"x1/2" TUBE	4	
3	TRUSS END POSTS	4"x4"x1/2" TUBE	8	
4	TRUSS VERTICALS	4"x4"x1/4" TUBE	14	
5A	TRUSS END DIAGONALS	4"x4"x1/2" TUBE	4	
5B	TRUSS INTERIOR DIAGONALS	4"x4"x1/4" TUBE	12	
6	FLOOR STRINGERS	4"x1 1/2" C-CHANNEL	5	
7A	FLOOR BEAMS 4&5	6"x6"x1/4" TUBE	3	
7B	FLOOR BEAMS 2 & 3	6"x4"x1/4" TUBE	4	
8	HORIZONTAL BRACING	6"x2 1/2" C-CHANNEL	8	
9	FLOOR END BEAMS	6"x4"x1/4" TUBE	2	
10	DECKING	12-IN. ALUMINUM DECK PLANKS	3/8" GAP	
11	BASE PLATE	9 1/2"x1'-4"x1/2" FLAT BAR	4	
12	BASE GUSSET	1/4" FLAT BAR GUSSET	12	
13	TOP CHORD END CAP	1/4" FLAT BAR END CAP	4	
14	COMBINATION RAIL	42" COMBINATION RAIL W/ 4" MAX SPACING	2 @ 39'-10" EACH	
15	RAIL BRACKET	3/8" PLATE	36	
16	DECK CORNER GUSSETS	1/4" DECK CORNER GUSSETS	8	
BP1	BEARING PAD	9 1/2"x1'-6"x1" UHMW PAD	4 x 7 = 28	~5 LBS (EACH)





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4	04/15/2020	12-IN ALUM. DECK PLANKS
5	05/29/2020	STAMPED SUBMITTAL

PROJECT NAME:

DNREC KILLENS POND PEDESTRIAN BRIDGE

CUSTOMER NAME:

DELAWARE DIVISION OF PARKS & RECREATION

CUSTOMER ADDRESS:

89 KINGS HIGHWAY DOVER, DELAWARE 19901

PROJECT LOCATION:

5025 KILLENS POND ROAD FELTON, DE 19943

CMI ORDER NO.:

Q98254

CUSTOMER PO NO.:

	NAME	DATE
DRAWN BY:	KLC	05/22/2020
CHECKED BY:	MKL	05/29/2020
FABRICATION:	BRS	05/29/2020

DRAWING NO.:

-4

SPANS 11,12,14,15,17,18,19: MATERIAL LIST

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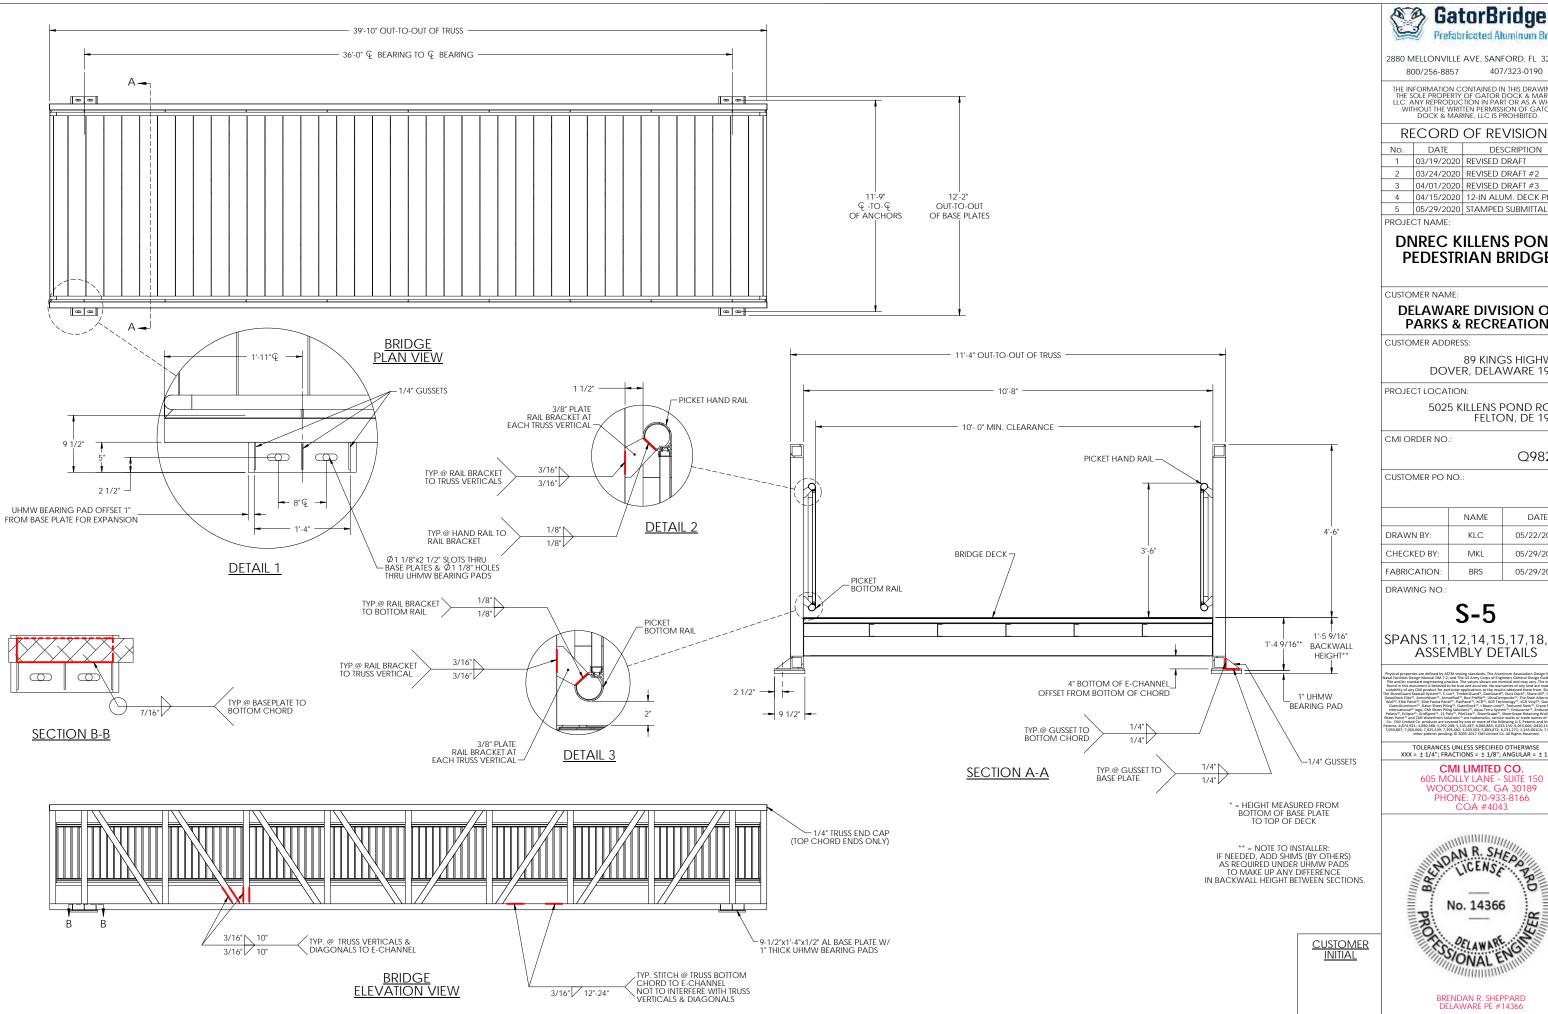
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CMI LIMITED CO.

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DNREC KILLENS POND PEDESTRIAN BRIDGE

CUSTOMER NAME:

DELAWARE DIVISION OF PARKS & RECREATION

CUSTOMER ADDRESS:

89 KINGS HIGHWAY DOVER, DELAWARE 19901

PROJECT LOCATION:

5025 KILLENS POND ROAD FELTON, DE 19943

CMI ORDER NO.:

Q98254

CUSTOMER PO NO .:

	NAME	DATE
DRAWN BY:	KLC	05/22/2020
CHECKED BY:	MKL	05/29/2020
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DRAWING NO.:

S-5


SPANS 11,12,14,15,17,18,19: **ASSEMBLY DETAILS**

TOLERANCES UNLESS SPECIFIED OTHERWISE XXX = ± 1/4"; FRACTIONS = ± 1/8"; ANGULAR = ± 1°


CMI LIMITED CO.

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TRUSS ELEVATION VIEW (QUANTITY x2)

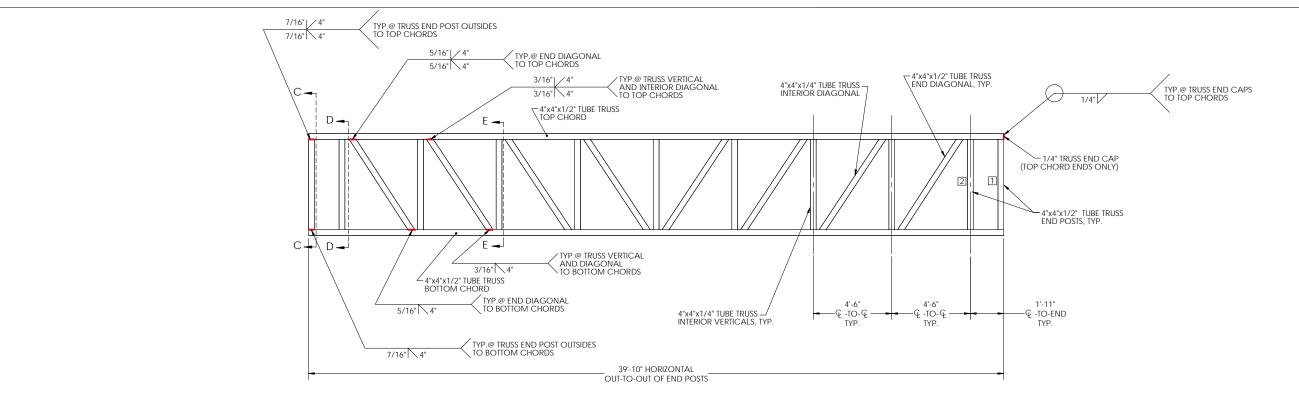

TRUSS SECTION C-C TRUSS SECTION D-D

4"x4"x1/2" TUBE TRUSS BOTTOM CHORD

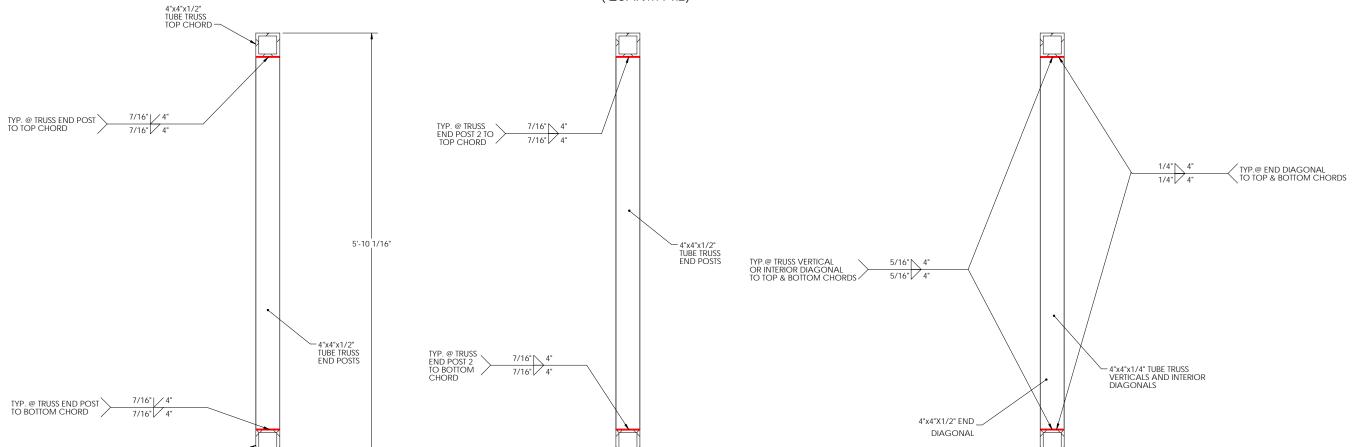TRUSS SECTION E-E



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5	05/29/2020	STAMPED SUBMITTAL

PROJECT NAME:

DNREC KILLENS POND PEDESTRIAN BRIDGE

CUSTOMER NAME:

DELAWARE DIVISION OF PARKS & RECREATION

CUSTOMER ADDRESS:

89 KINGS HIGHWAY DOVER, DELAWARE 19901

PROJECT LOCATION:

5025 KILLENS POND ROAD FELTON, DE 19943

CMI ORDER NO.:

Q98254

CUSTOMER PO NO .:

	NAME	DATE
DRAWN BY:	KLC	05/22/2020
CHECKED BY:	MKL	05/29/2020
FABRICATION:	BRS	05/29/2020

DRAWING NO.:

CUSTOMER INITIAL **S-6**

SPANS 11,12,14,15,17,18,19: TRUSS DETAILS

Physical properties are defined by ATTM testing standards, The Aluminum Association Design Manual. The Piles and/or standard emplement practice. The suless showers are sensitive and results of the piles and provided emplement practice. The suless showers are sensitive and results of the piles and provided and provi


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CMI LIMITED CO.

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DELAWARE PE #14366



GatorBridge

407/323-0190
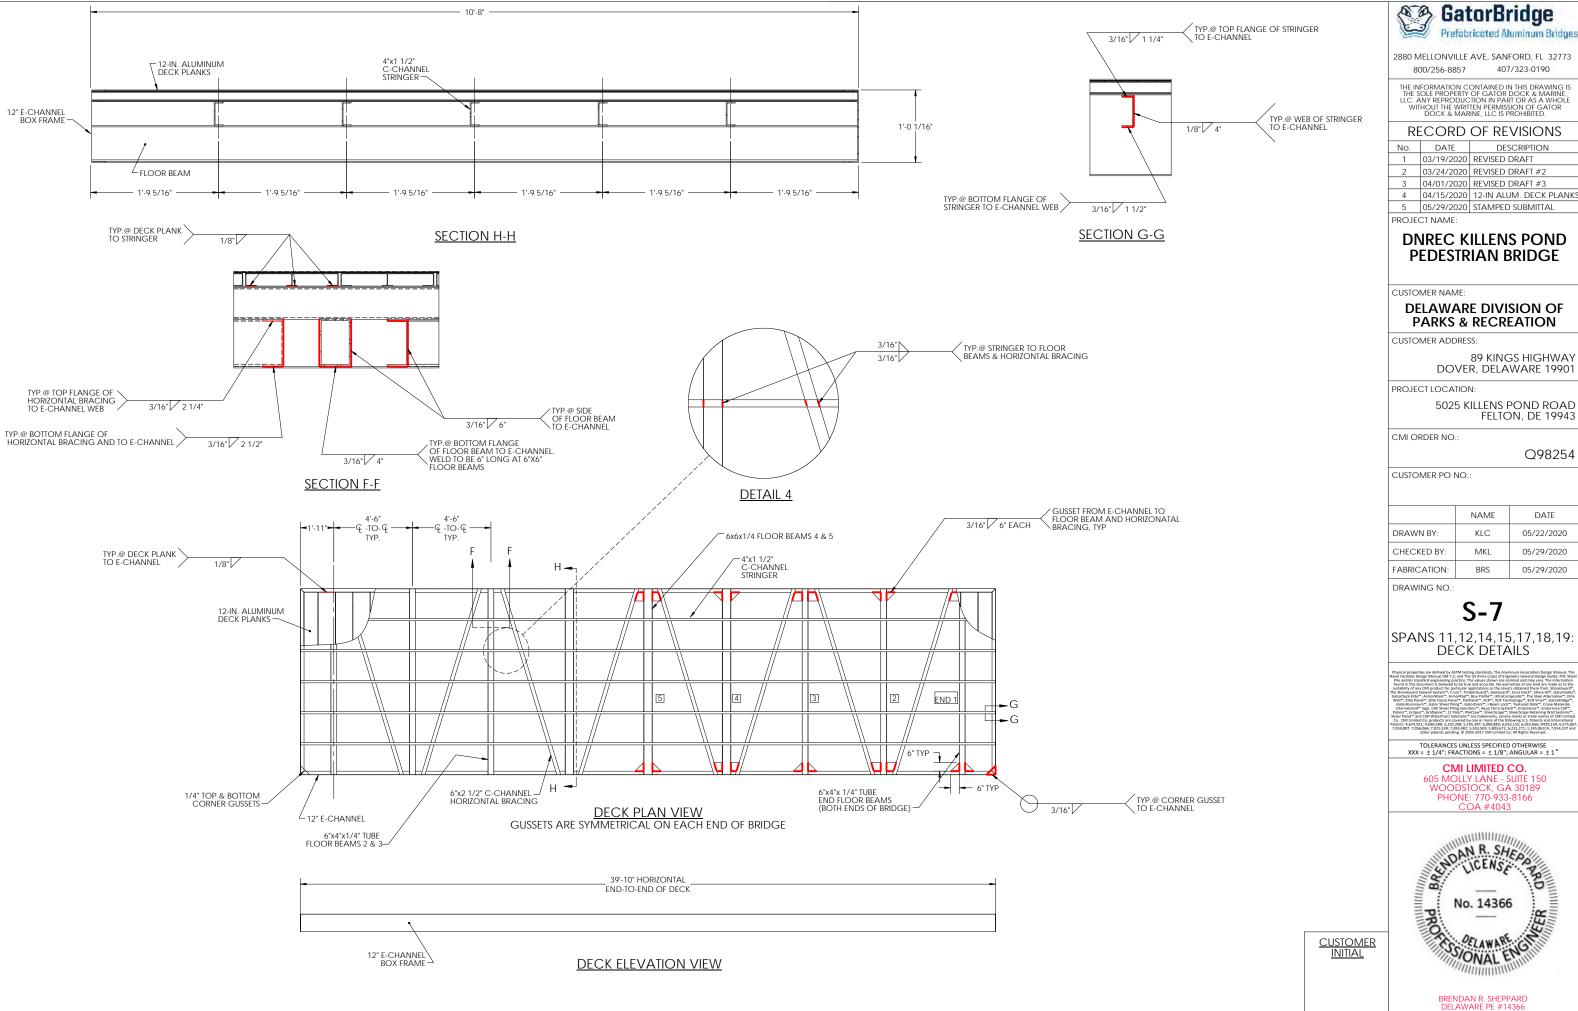
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4	04/15/2020	12-IN ALUM. DECK PLANK

DNREC KILLENS POND PEDESTRIAN BRIDGE

DELAWARE DIVISION OF PARKS & RECREATION

89 KINGS HIGHWAY DOVER, DELAWARE 19901

FELTON, DE 19943

Q98254


	NAME	DATE
DRAWN BY:	KLC	05/22/2020
CHECKED BY:	MKL	05/29/2020
FABRICATION:	BRS	05/29/2020

SPANS 11,12,14,15,17,18,19: DECK DETAILS

CMI LIMITED CO.



BILL OF MATERIALS					
ITEM # TYPE DESCRIPTION		QTY/COMMENTS	WEIGHTS		
SPA	N 6	BRIDGE	10'x83'-10" CASCADE BRIDGE	1	~15,600 LBS
	1	BOX FRAME	12" E-CHANNEL	1	
	2	TRUSS CHORDS	8"x8"x1/2" TUBE	4	
	3	TRUSS END POSTS	8"x8"x1/2" TUBE	8	
	4A	TRUSS VERTICALS 1-4	6"x6"x1/4" TUBE	16	
	4B	TRUSS VERTICALS 5-8	6"x6"x1/2" TUBE	14	
	5A	TRUSS END DIAGONALS	6"x6"x1/2" TUBE	4	
	5B	TRUSS DIAGONAL 1	4"x4"x1/2" TUBE	4	
	5C	TRUSS DIAGONALS 2-7	4"x4"x1/4" TUBE	24	
	6	FLOOR STRINGERS	4"x1 1/2" C-CHANNEL	5	
	7A	FLOOR BEAMS 8 & 9	6"x6"x1/2" TUBE	3	
	7B	FLOOR BEAMS 2-7	6"x6"x1/4" TUBE	12	
	8 HORIZONTAL BRACING 6"x4"x1/4" TUBE		16		
	9	FLOOR END BEAMS	6"x6"x1/4" TUBE	2	
	10	DECKING	12-IN. ALUMINUM DECK PLANK	3/8" GAP.	
	11	BASE PLATE	1'-2"x1'-4"x1/2" FLAT BAR	4	
	12	BASE GUSSET	1/4" FLAT BAR GUSSET	12	
	13	TOP CHORD END CAP	1/4" FLAT BAR END CAP	4	
	14	COMBINATION RAIL	42" COMBINATION RAIL W/ 4" MAX SPACING	2	
	15	RAIL BRACKET	3/8" PLATE	58	
	16	DECK CORNER GUSSETS	1/4" DECK CORNER GUSSETS	8	
BP	2	BEARING PAD	1'-2"x1'-6"x1" UHMW PAD	4	~5 LBS (EACH)

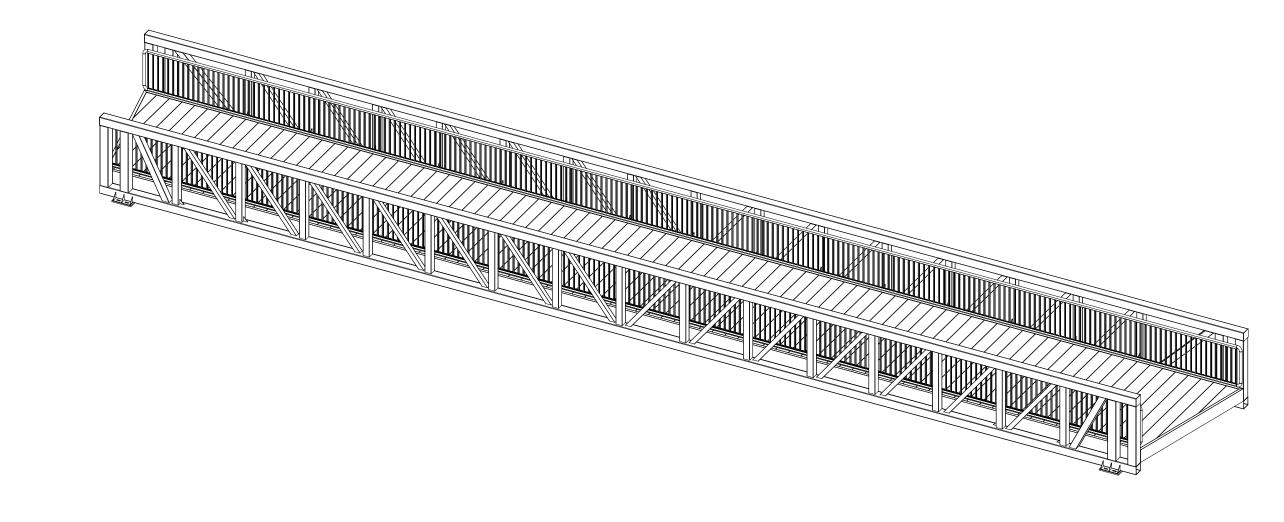



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5	05/29/2020	STAMPED SUBMITTAL

PROJECT NAME:

DNREC KILLENS POND PEDESTRIAN BRIDGE

CUSTOMER NAME:

DELAWARE DIVISION OF PARKS & RECREATION

CUSTOMER ADDRESS:

89 KINGS HIGHWAY DOVER, DELAWARE 19901

PROJECT LOCATION:

5025 KILLENS POND ROAD FELTON, DE 19943

CMI ORDER NO .:

Q98254

CUSTOMER PO NO.:

	NAME	DATE
DRAWN BY:	VRP	05/29/2020
CHECKED BY:	BRS	05/29/2020
FABRICATION:	BRS	05/29/2020

DRAWING NO.:

S-8


BRIDGE SPAN 6: MATERIAL LIST

Nacid Facilities Design Natural DN 22, and The US Amir Conjor of Engineers General Design Guider PM States Pile Sandfort States demposering practice. The calculast Source are commissed and may on a five information in the state of the st


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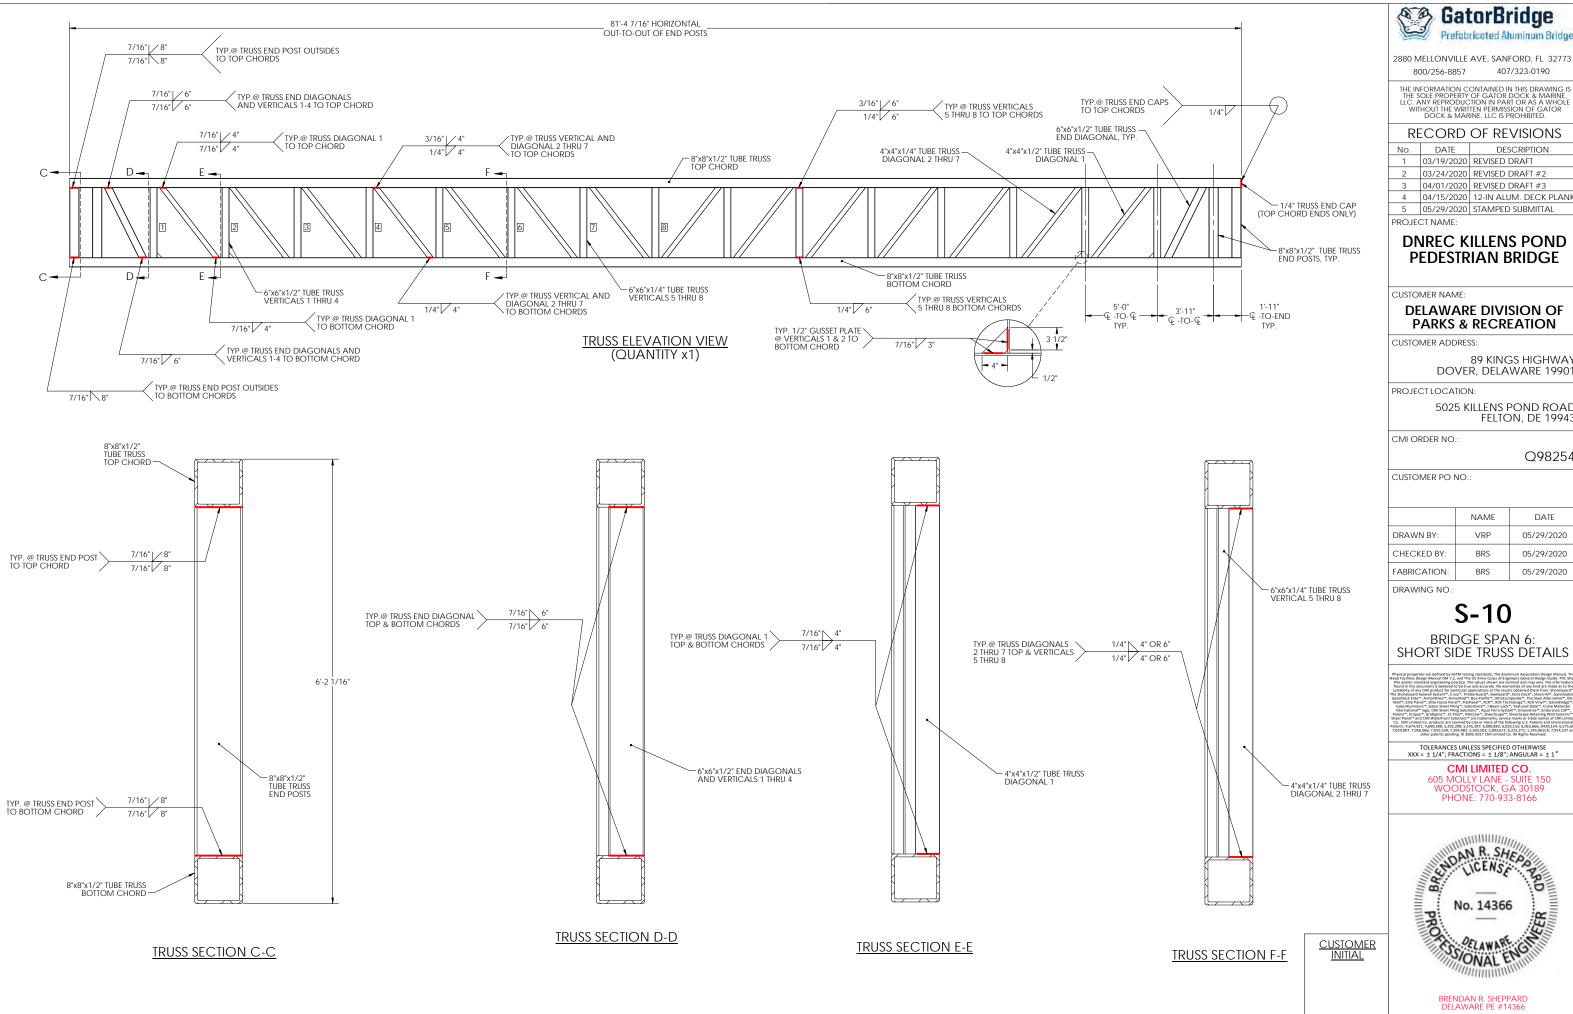
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GatorBridge
Prefabricated Aluminum Bri

407/323-0190

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PEDESTRIAN BRIDGE

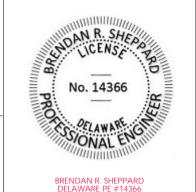89 KINGS HIGHWAY DOVER, DELAWARE 19901


5025 KILLENS POND ROAD FELTON, DE 19943

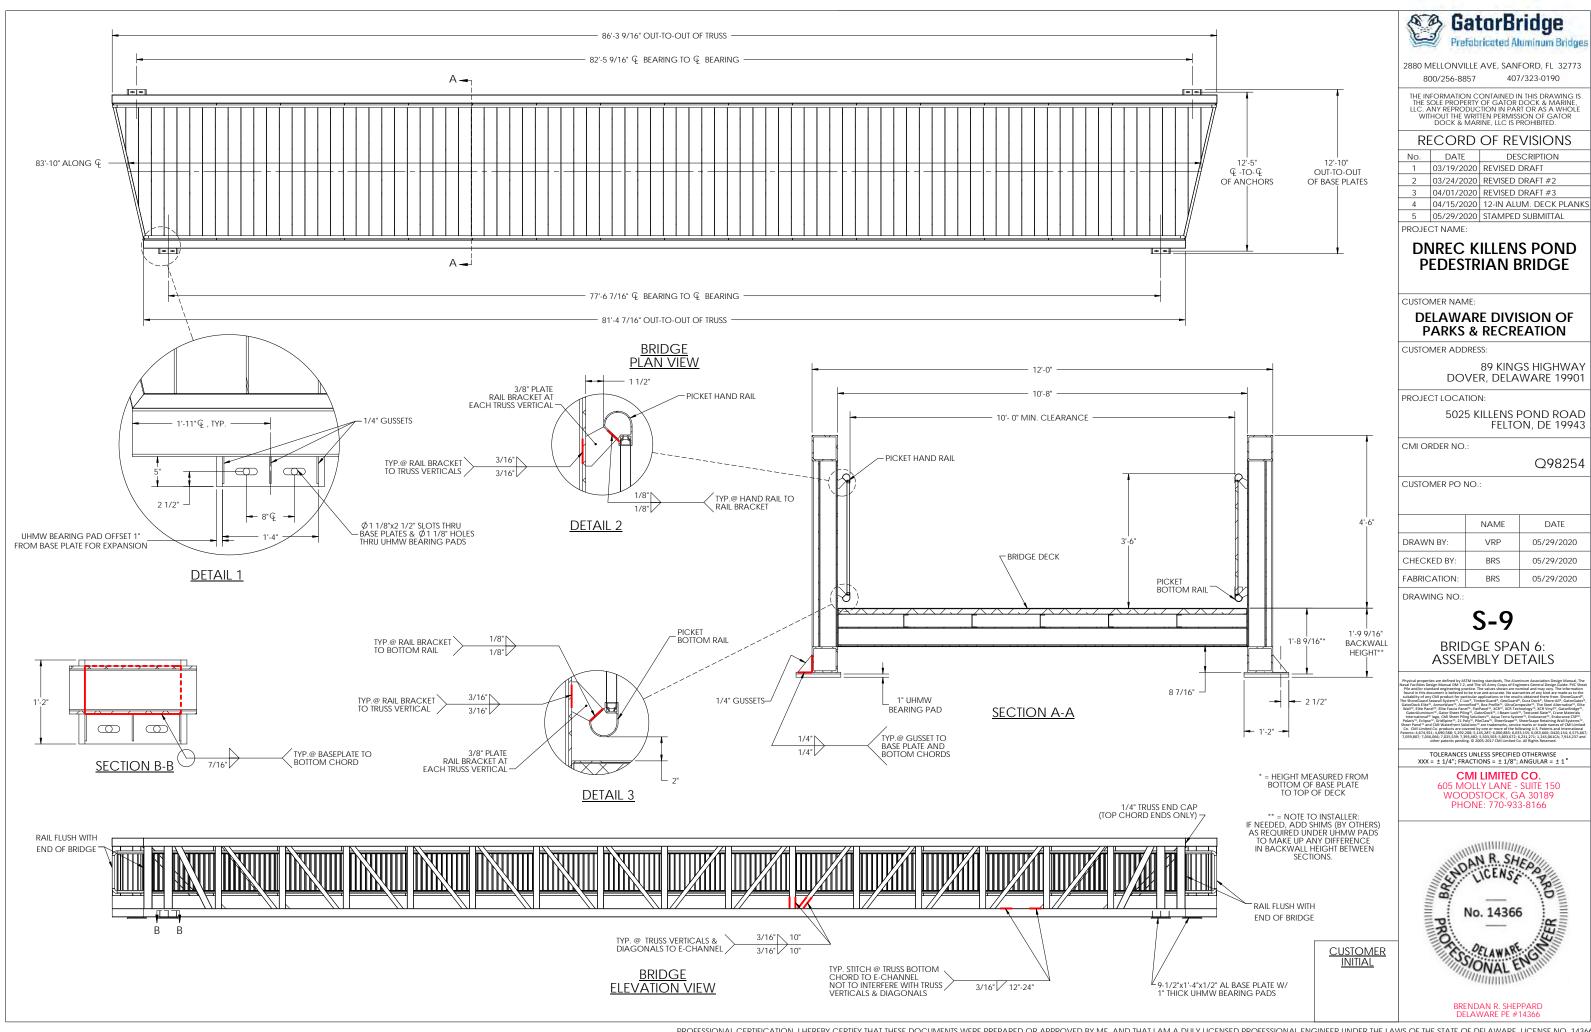
Q98254

	NAME	DATE
DRAWN BY:	VRP	05/29/2020
CHECKED BY:	BRS	05/29/2020
FABRICATION:	BRS	05/29/2020

SHORT SIDE TRUSS DETAILS



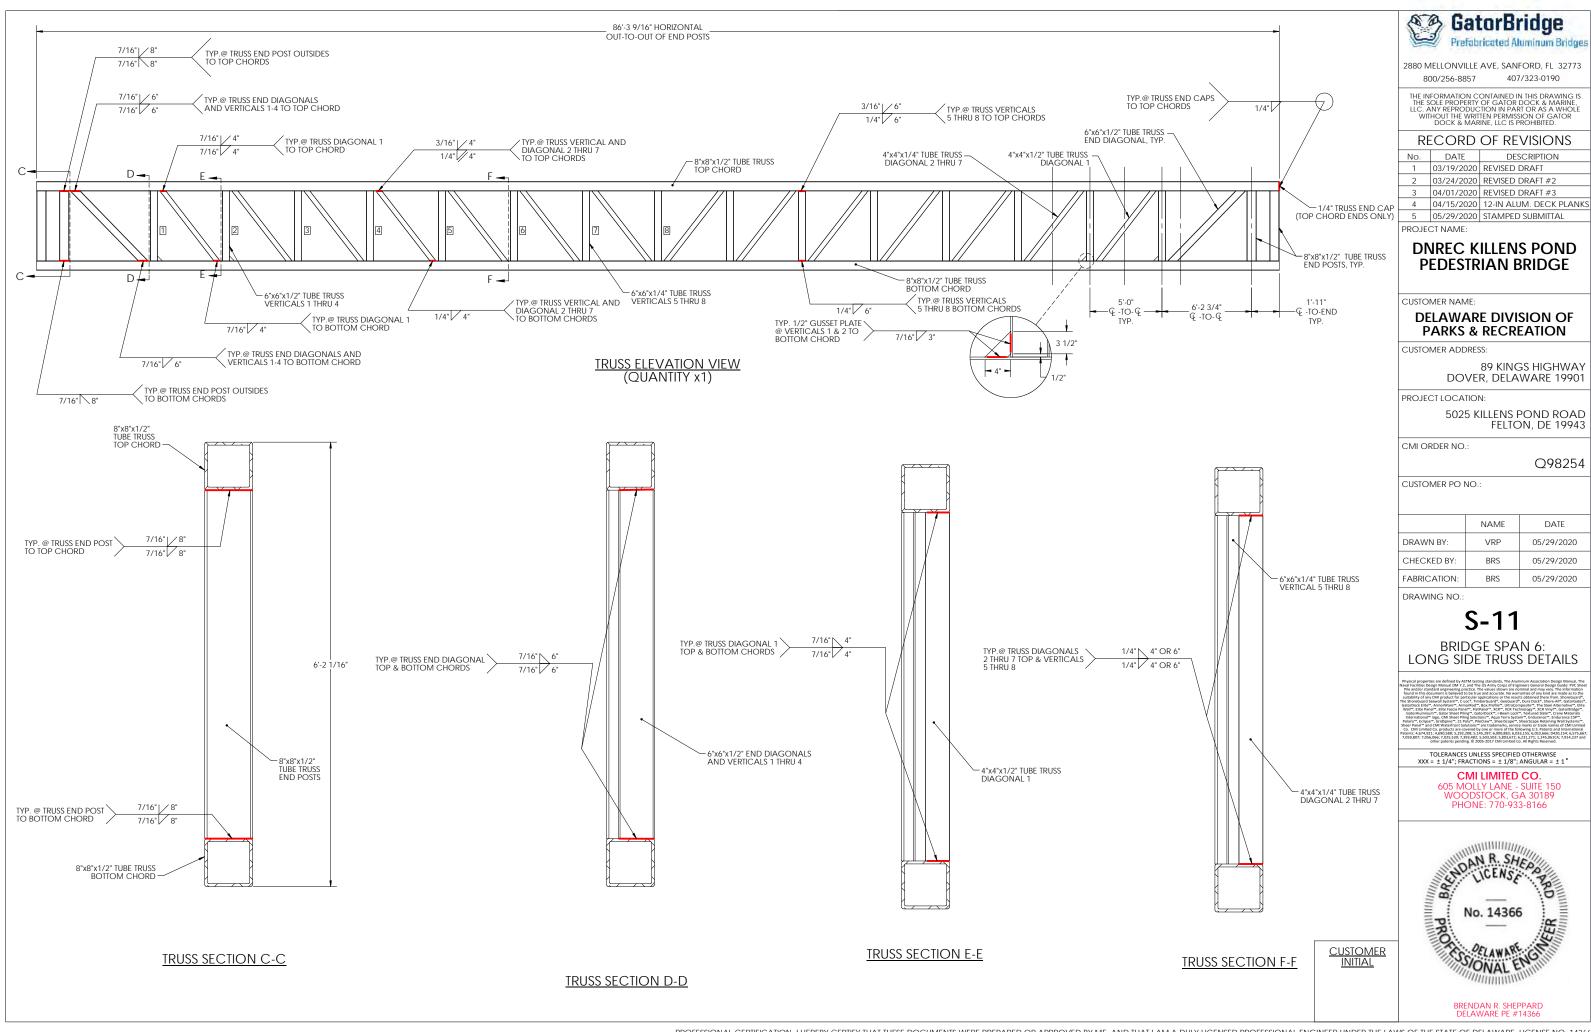

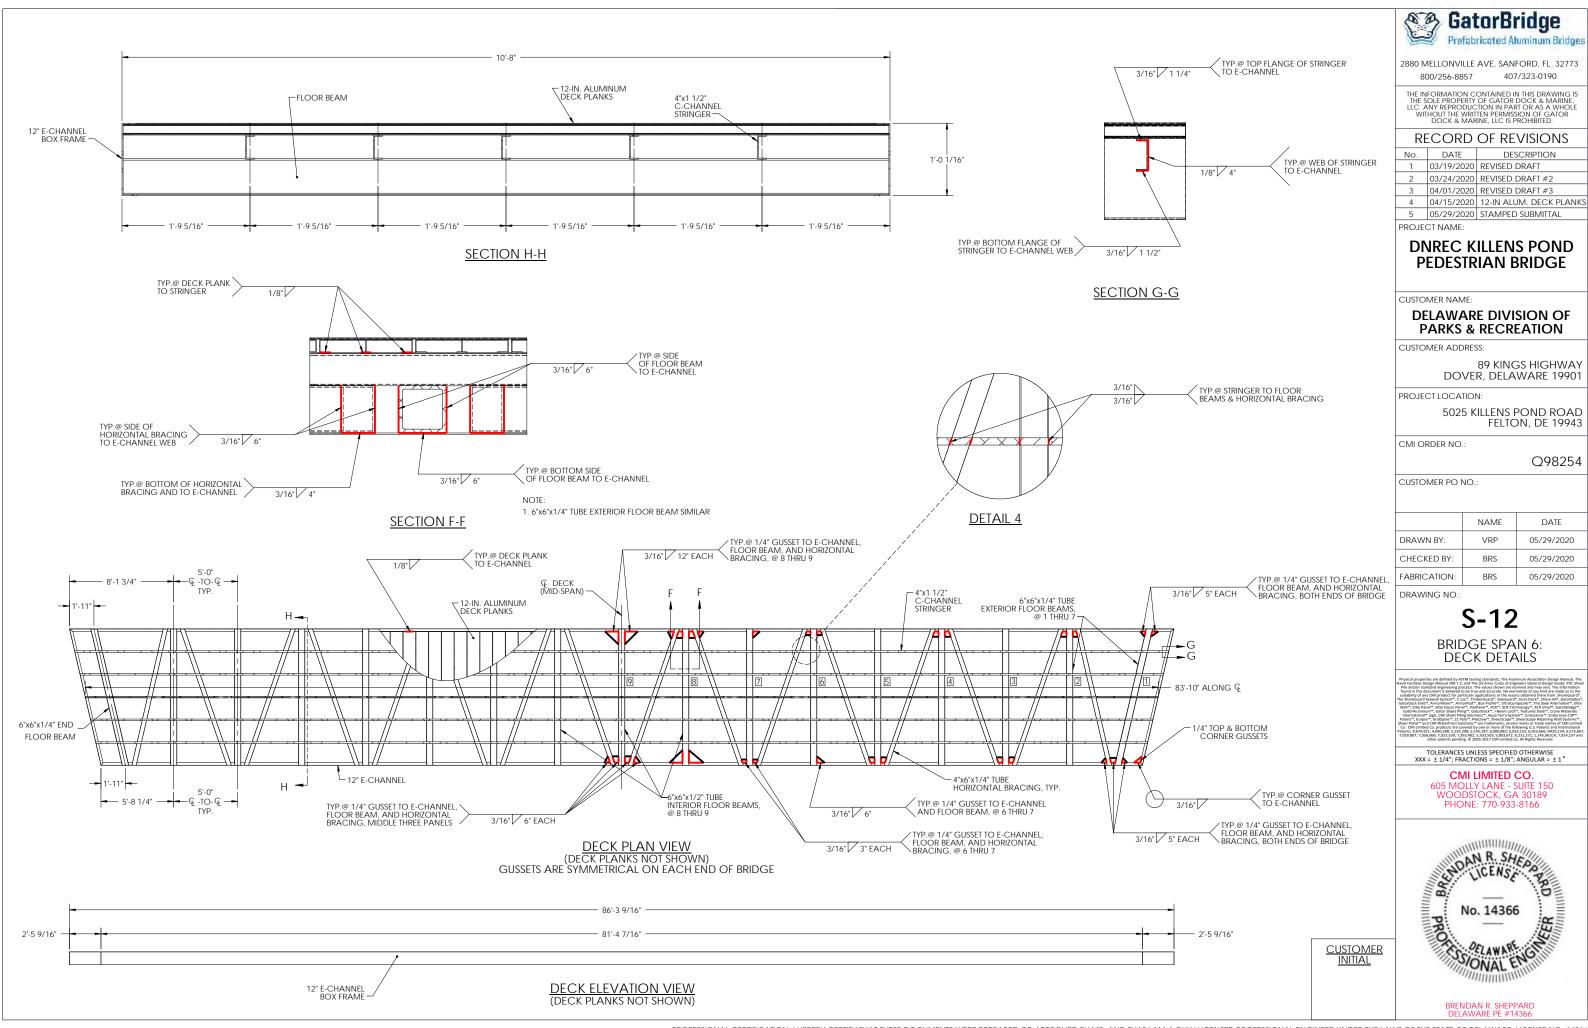

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BILL OF MATERIALS				
ITEM #	ТҮРЕ	DESCRIPTION	QTY/COMMENTS	WEIGHTS
SPAN 1	BRIDGE	10'x32'-10" CASCADE BRIDGE	## Commons ## Co	~4,300 LBS
1	BOX FRAME	12" E-CHANNEL	1	
2	TRUSS CHORDS	4"x4"x1/2" TUBE	4	
3	TRUSS END POSTS	4"x4"x1/2" TUBE	8	
4	TRUSS VERTICALS	4"x4"x1/4" TUBE	10	
5	TRUSS DIAGONALS	4"x4"x1/4" TUBE	12	
6	FLOOR STRINGERS	4"x1 1/2" C-CHANNEL	5	
7	FLOOR BEAMS	6"x4"x1/4" TUBE	5	
8	HORIZONTAL BRACING	6"x2 1/2" C-CHANNEL	6	
9	FLOOR END BEAMS	6"x4"x1/4" TUBE	3	
10	DECKING	12-IN. ALUMINUM DECK PLANK	3/8" GAP	
11	BASE PLATE	9 1/2"x1'-4"x1/2" FLAT BAR	4	
12	BASE GUSSET	1/4" FLAT BAR GUSSET	12	
13	TOP CHORD END CAP	1/4" FLAT BAR END CAP	4	
14	COMBINATION RAIL	42" COMBINATION RAIL W/ 4" MAX SPACING	2	
15	RAIL BRACKET	3/8" PLATE	28	
16	DECK CORNER GUSSETS	1/4" DECK CORNER GUSSETS	8	
PAN 20	BRIDGE	10'x49'-8.5" CASCADE BRIDGE	1	~6,200 LBS
1	BOX FRAME	12" E-CHANNEL	1	
2	TRUSS CHORDS	4"x4"x1/2" TUBE	4	
3	TRUSS END POSTS	4"x4"x1/2" TUBE	8	
4	TRUSS VERTICALS	4"x4"x1/4" TUBE	14	
5	TRUSS END DIAGONALS	4"x4"x1/2" TUBE	2	
6	TRUSS INTERIOR DIAGONALS	4"x4"x1/4" TUBE	14	
7	FLOOR STRINGERS	4"x1 1/2" C-CHANNEL	5	
8	FLOOR BEAMS 4 & 5	6"x6"x1/4" TUBE	3	
9	FLOOR BEAMS 2 & 3	6"x4"x1/4" TUBE	4	
10	HORIZONTAL BRACING	6"x2 1/2" C-CHANNEL	8	
11	FLOOR END BEAMS	6"x4"x1/4" TUBE	3	
12	DECKING	12-IN. ALUMINUM DECK PLANK	3/8" GAP	
13	BASE PLATE	9 1/2"x1'-4"x1/2" FLAT BAR	4	
14	BASE GUSSET	1/4" FLAT BAR GUSSET		
	TOP CHORD END CAP	1/4" FLAT BAR END CAP		
15	- I		2	
16	COMBINATION RAIL	42" COMBINATION RAIL W/ 4" MAX SPACING	<u> </u>	
	COMBINATION RAIL RAIL BRACKET	42" COMBINATION RAIL W/ 4" MAX SPACING 3/8" PLATE	36	
16				



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4	04/15/2020	12-IN ALUM. DECK PLAN
5	05/29/2020	STAMPED SUBMITTAL

PROJECT NAME:

DNREC KILLENS POND PEDESTRIAN BRIDGE

CUSTOMER NAME:

DELAWARE DIVISION OF PARKS & RECREATION

CUSTOMER ADDRESS:

89 KINGS HIGHWAY DOVER, DELAWARE 19901

PROJECT LOCATION:

5025 KILLENS POND ROAD FELTON, DE 19943

CMI ORDER NO.:

Q98254

CUSTOMER PO NO.:

	NAME	DATE
DRAWN BY:	KLC	05/20/2020
CHECKED BY:	MKL	05/29/2020
FABRICATION:	BRS	05/29/2020

DRAWING NO.:

S-13


SPANS 1 AND 20: MATERIAL LIST


TOLERANCES UNLESS SPECIFIED OTHERWISE XXX = ± 1/4"; FRACTIONS = ± 1/8"; ANGULAR = ± 1°


CMI LIMITED CO.

CIVII LIMITED CO. 605 MOLLY LANE - SUITE 150 WOODSTOCK, GA 30189 PHONE: 770-933-8166 COA #4043




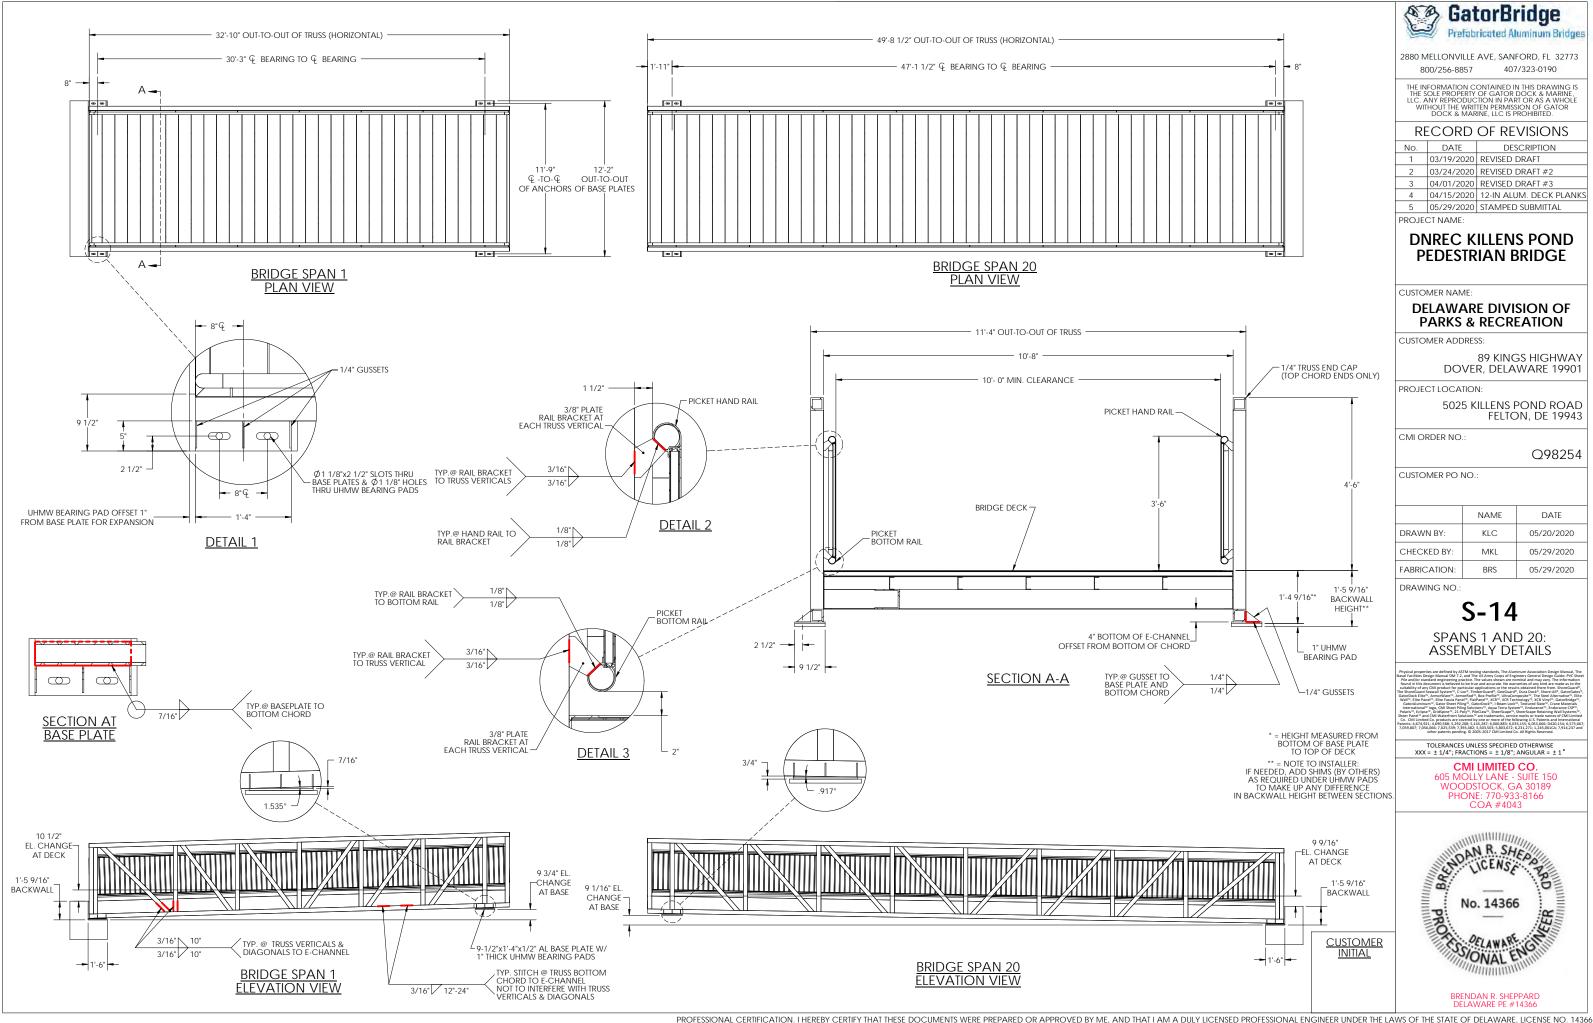

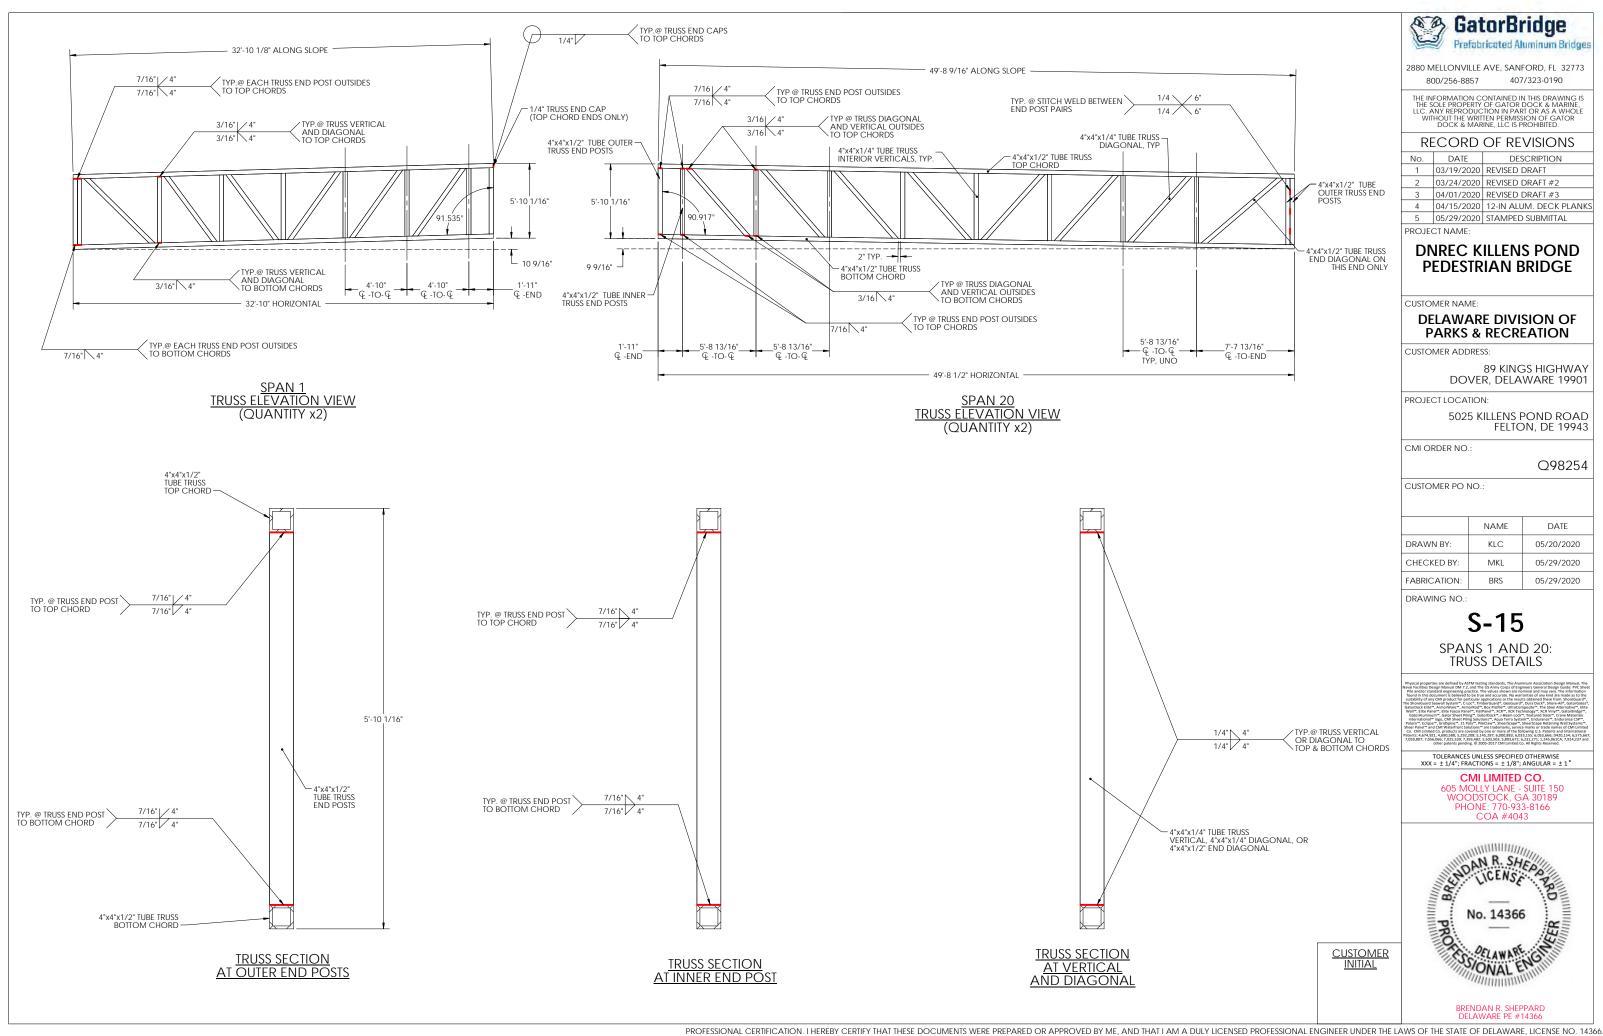

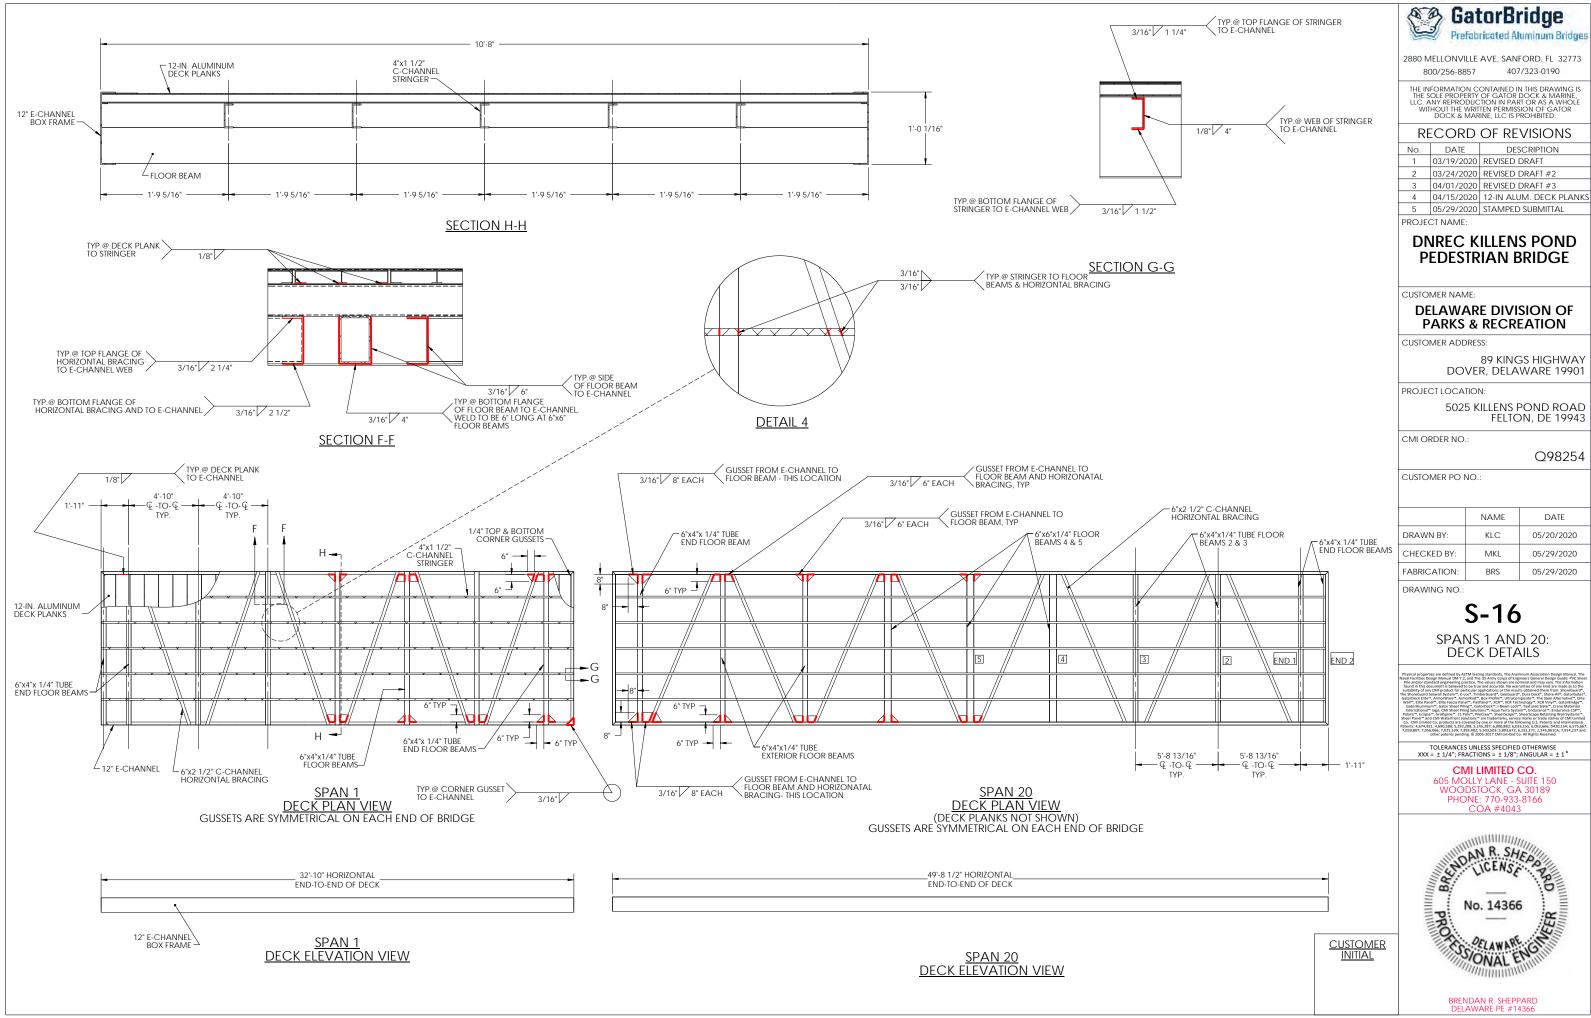

BILL OF MATERIALS					
ITEI	M #	TYPE	DESCRIPTION	QTY/COMMENTS	WEIGHTS
	2, 10, ND 16	BRIDGE	10'x39'-10" FISHING PIER BRIDGE	4	~4,100 LBS
	1	BOX FRAME	12" E-CHANNEL	2	
	2	TRUSS CHORDS	4"x4"x1/2" TUBE	6	
	3	TRUSS END POSTS	4"x4"x1/2" TUBE	4	
	4A	TRUSS VERTICALS	4"x4"x1/4" TUBE	6	
	4B	TRUSS SPLICE POST	2"x4"x1/4" TUBE	2	
	5	TRUSS DIAGONALS	4"x4"x1/4" TUBE	8	
	6	FLOOR STRINGERS	4"x1 1/2" C-CHANNEL	5	
	7	FLOOR BEAMS	6"x6"x1/4" TUBE	6	
	8	FLOOR END BEAMS	6"x6"x1/4" TUBE	2	
	9	FLOOR END BRACING	6"x2 1/2" C-CHANNEL	2 (01 CAP	
	10	DECKING	12-IN. ALUMINUM DECK PLANKS	3/8" GAP	
	11	BASE PLATE	9 1/2"x8"x1/2" FLAT BAR	4	
	12	BASE PLATE	9 1/2"x1'-4"x1/2" FLAT BAR	8	
	13	BASE GUSSET	1/4" FLAT BAR GUSSET	32	
	14	TOP CHORD END CAP	1/4" FLAT BAR END CAP 42" COMBINATION RAIL W/ 4" MAX		
	15	COMBINATION RAIL	SPACING	1	
	16	RAIL BRACKET	3/8" PLATE	20	
	17	DECK CORNER GUSSETS	1/4" DECK CORNER GUSSETS	16	
	18	SPLICE FASTENER @ SPLICE VERTICALS	5/8"x5 1/2" SS HEX BOLT	4	
	19	SPLICE FASTENER @ END	5/8"x2" SS HEX BOLT	10	
	20	SPLICE FASTENER @ SIDE	5/8"x2" SS HEX BOLT	32	
	21	SPLICE FASTENER	5/8" SS HEX NUT	42	
	22	SPLICE FASTENER	5/8" SS WASHER	84	
	23	SPLICE FASTENER	5/8" NYLON WASHER	84	
ED /	AME	FRAME	10'x39'-10" FISHING	4 SETS	~3,000 LBS
rk <i>F</i>			PIER FRAME		~3,000 LB3
	1	BOX FRAME	12" E-CHANNEL	2	
	2	TRUSS CHORDS	4"x4"x1/2" TUBE	6	
	3	FLOOR STRINGERS	4"x1 1/2" C-CHANNEL	5	
	4	FLOOR BEAMS	6"x6"x1/4" TUBE	6	
	5	FLOOR END BRACING	6"x2 1/2" C-CHANNEL	2	
	6	DECKING	12-IN. ALUMINUM DECK PLANKS	3/8" GAP	
	7	BASE PLATE	9 1/2"x8"x1/2" FLAT BAR	4	
	8	BASE PLATE	9 1/2"x1'-4"x1/2" FLAT BAR	6	
	9	BASE GUSSET	1/4" FLAT BAR GUSSET	26	
	10	DECK CORNER GUSSETS	1/4" DECK CORNER GUSSETS	16	
	11	SPLICE FASTENER @ END	5/8"x2" SS HEX BOLT	10	
	12	SPLICE FASTENER	5/8" SS HEX NUT	10	
	13	SPLICE FASTENER	5/8" SS WASHER	20	
	23	SPLICE FASTENER	5/8" NYLON WASHER	20	
RA	IL 1	FISHING RAIL 1	FISHING RAIL 20'-0"	1 x 4 = 4	~250 LBS
RAI	L 2A	FISHING RAIL 2A	FISHING RAIL 13'-7"	1 x 4 = 4	~210 LBS
RAI	L 2B	FISHING RAIL 2B	FISHING RAIL 13'-7"	1 x 4 = 4	~210 LBS
ВІ	P1	BEARING PAD	9 1/2"x1'-6"x1" UHMW PAD	14 x 4 = 56	~5 LBS (EACH)
ВІ	P3	BEARING PAD	9 1/2"x8"x1" UHMW PAD	8 x 4 = 32	~5 LBS (EACH)

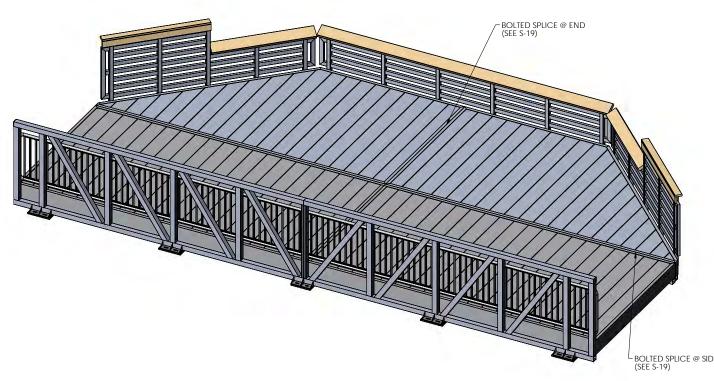



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4	04/15/2020	12-IN ALUM. DECK PLANK
5	05/29/2020	STAMPED SUBMITTAL

PROJECT NAME:

DNREC KILLENS POND PEDESTRIAN BRIDGE

CUSTOMER NAME:

DELAWARE DIVISION OF PARKS & RECREATION

CUSTOMER ADDRESS:

89 KINGS HIGHWAY DOVER, DELAWARE 19901

PROJECT LOCATION:

5025 KILLENS POND ROAD FELTON, DE 19943

CMI ORDER NO.:

Q98254

CUSTOMER PO NO.:

	NAME	DATE
DRAWN BY:	VRP	5/29/2020
CHECKED BY:	MKL	5/29/2020
FABRICATION:	BRS	5/29/2020

DRAWING NO.:

S-17

SPANS 2,10,13,16: MATERIAL LIST


TOLERANCES UNLESS SPECIFIED OTHERWISE XXX = ± 1/4"; FRACTIONS = ± 1/8"; ANGULAR = ± 1°


CMI LIMITED CO.

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FISHING PIER ELEVATION VIEW

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DNREC KILLENS POND PEDESTRIAN BRIDGE

DELAWARE DIVISION OF PARKS & RECREATION

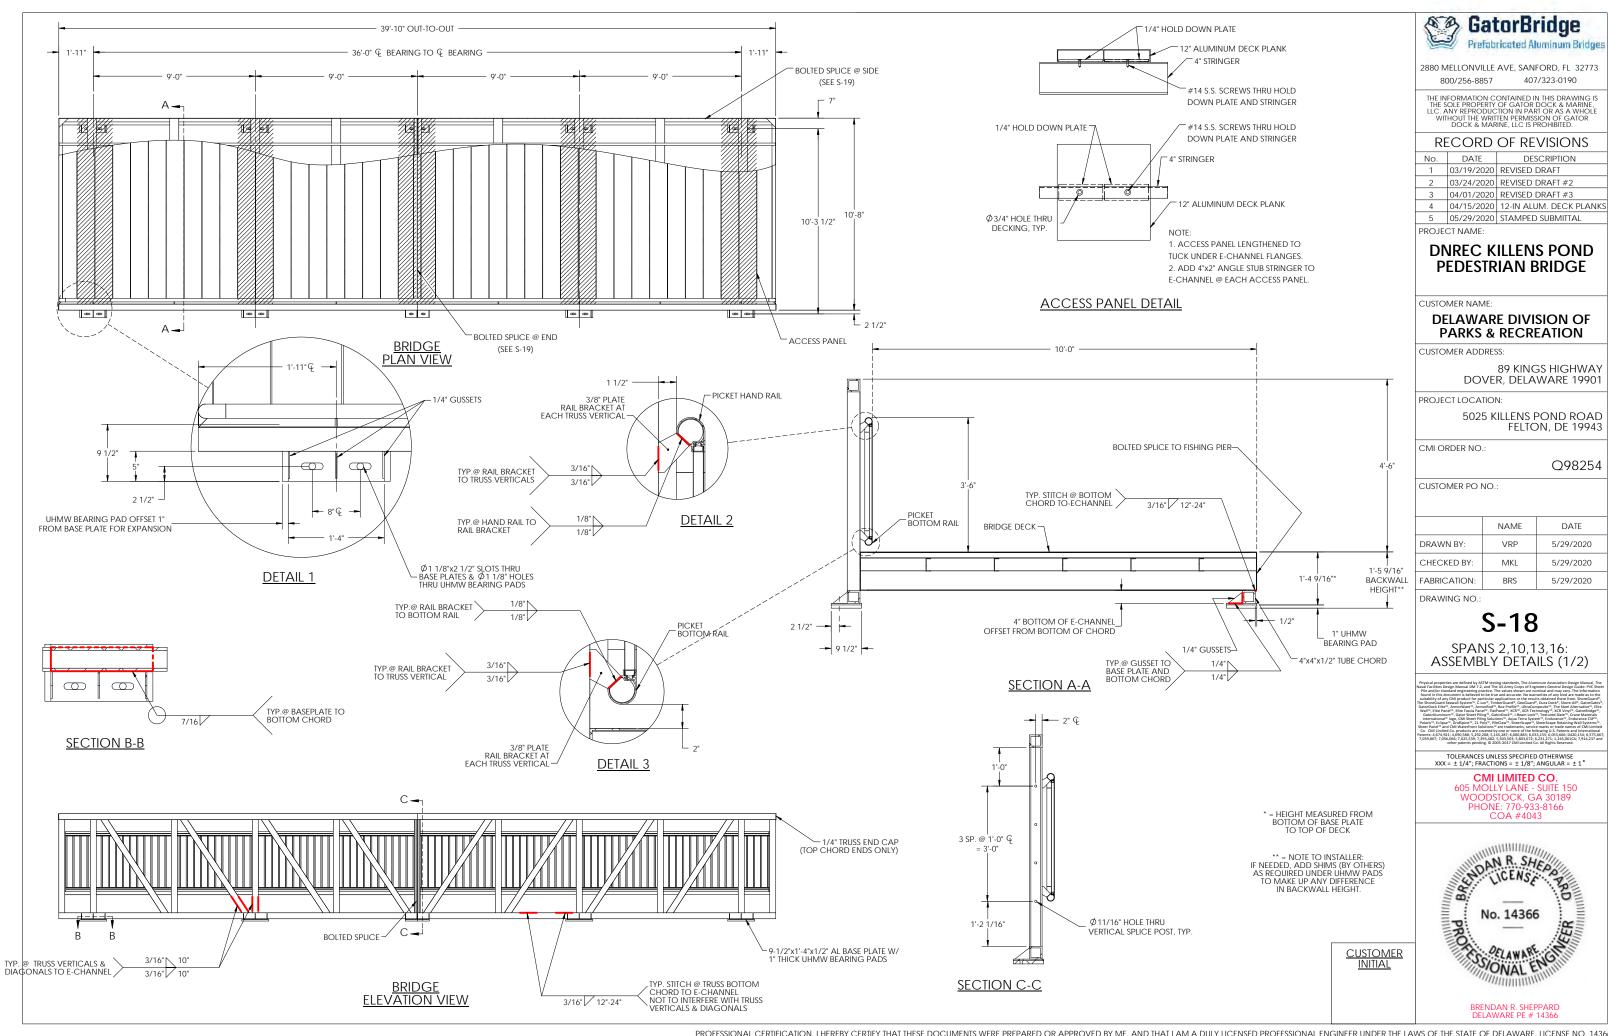89 KINGS HIGHWAY DOVER, DELAWARE 19901

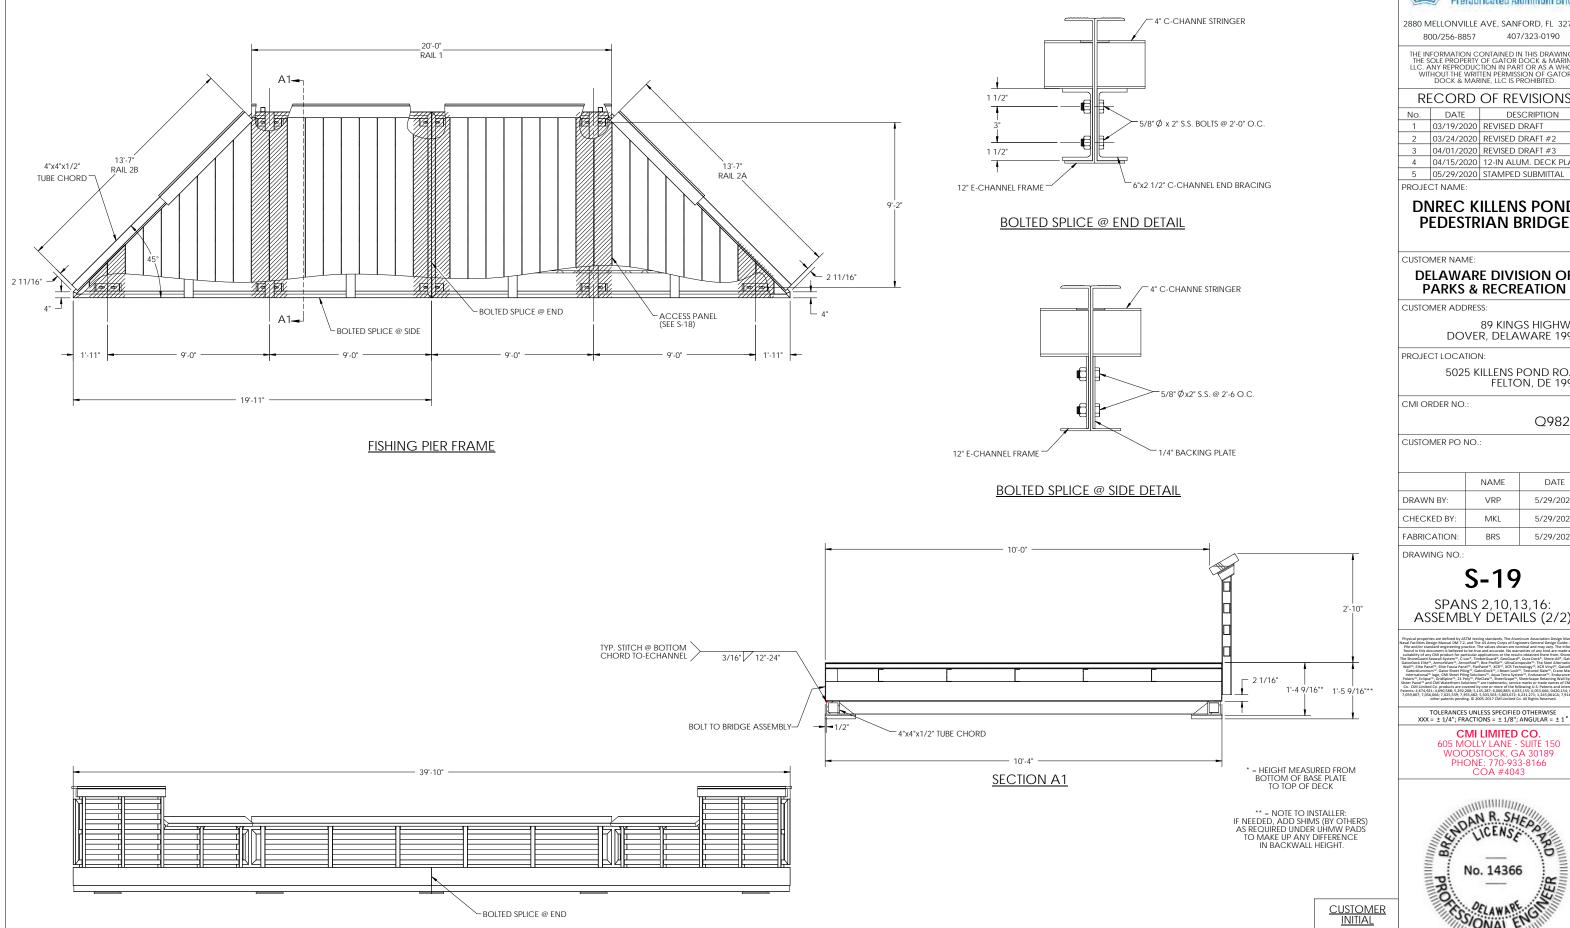5025 KILLENS POND ROAD FELTON, DE 19943

Q98254


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DRAWN BY:	VRP	5/29/2020		
CHECKED BY:	MKL	5/29/2020		
FABRICATION:	BRS	5/29/2020		


S-19

SPANS 2,10,13,16: ASSEMBLY DETAILS (2/2)

CMI LIMITED CO.

CON ENHIFE CO. 605 MOLLY LANE - SUITE 150 WOODSTOCK, GA 30189 PHONE: 770-933-8166 COA #4043

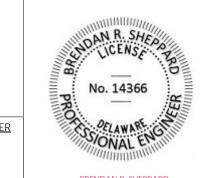

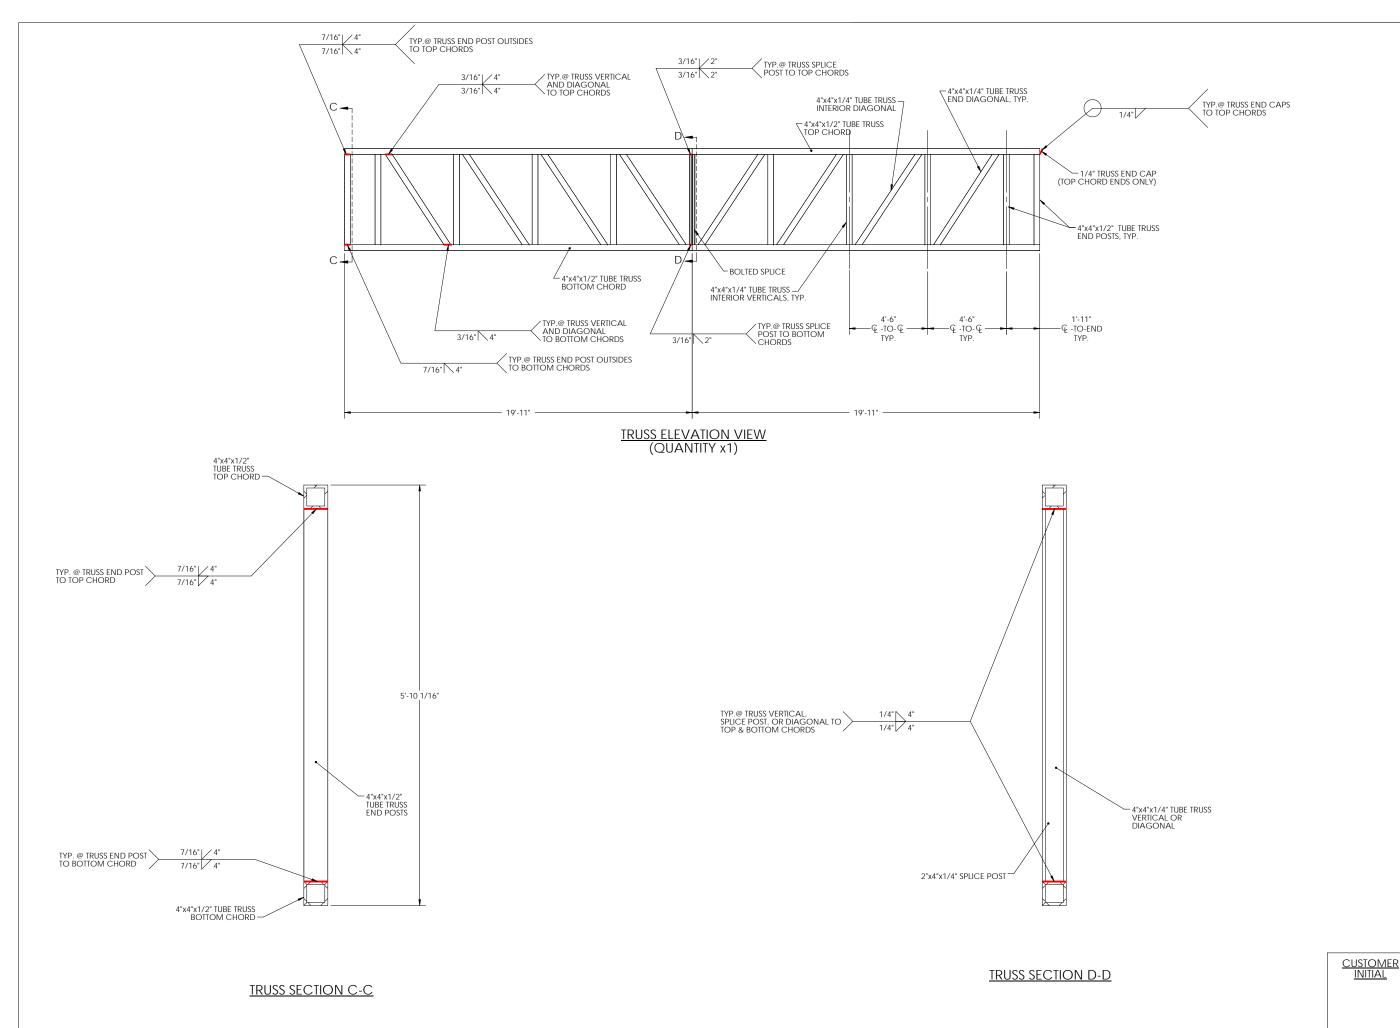

GatorBridge
Prefabricated Aluminum Bridge

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5	05/29/2020	STAMPED SUBMITTAL

PROJECT NAME:

DNREC KILLENS POND PEDESTRIAN BRIDGE

CUSTOMER NAME:

DELAWARE DIVISION OF PARKS & RECREATION

CUSTOMER ADDRESS:

89 KINGS HIGHWAY DOVER, DELAWARE 19901

PROJECT LOCATION:

5025 KILLENS POND ROAD FELTON, DE 19943

CMI ORDER NO.:

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FABRICATION:	BRS	5/29/2020

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S-20


SPANS 2,10,13,16: TRUSS DETAILS


all and/or standard engineering practice. The values shown are normal and may very. The information was all and on the control of the control

TOLERANCES UNLESS SPECIFIED OTHERWISE XXX = ± 1/4"; FRACTIONS = ± 1/8"; ANGULAR = ± 1°

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PROJECT NAME:

DNREC KILLENS POND PEDESTRIAN BRIDGE

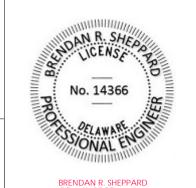CUSTOMER NAME:

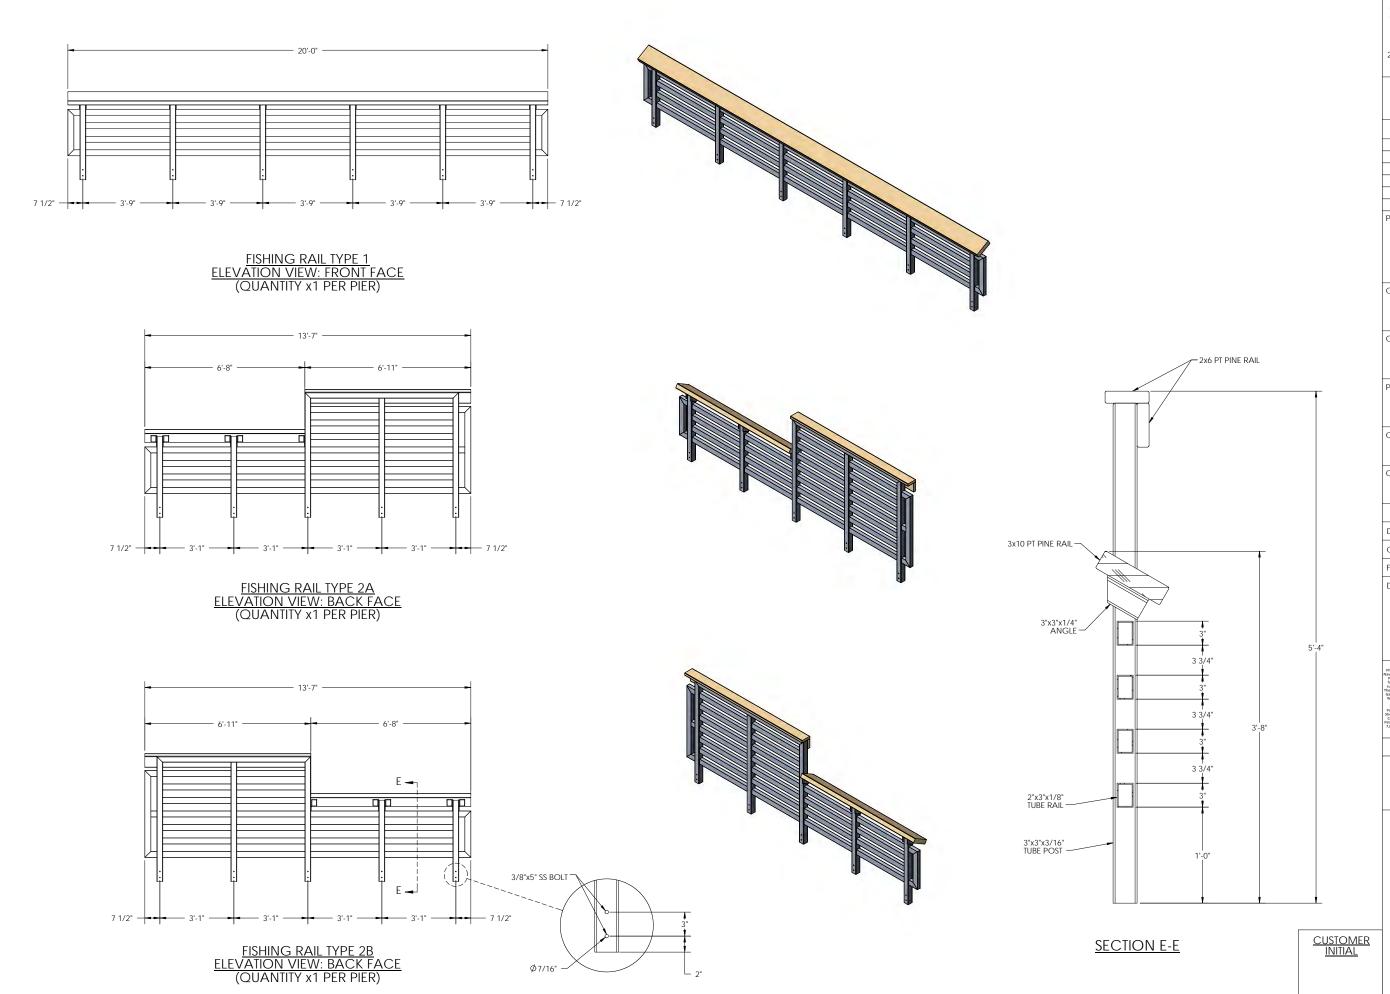DELAWARE DIVISION OF PARKS & RECREATION

CUSTOMER ADDRESS:

89 KINGS HIGHWAY DOVER, DELAWARE 19901

PROJECT LOCATION:

5025 KILLENS POND ROAD FELTON, DE 19943

CMI ORDER NO.:

Q98254

CUSTOMER PO NO.:

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CHECKED BY:	MKL	5/29/2020
FABRICATION:	BRS	5/29/2020

DRAWING NO.:


S-21

SPANS 2,10,13,16: FISHING RAIL DETAILS

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DNREC KILLENS POND PEDESTRIAN BRIDGE

PARKS & RECREATION

89 KINGS HIGHWAY DOVER, DELAWARE 19901

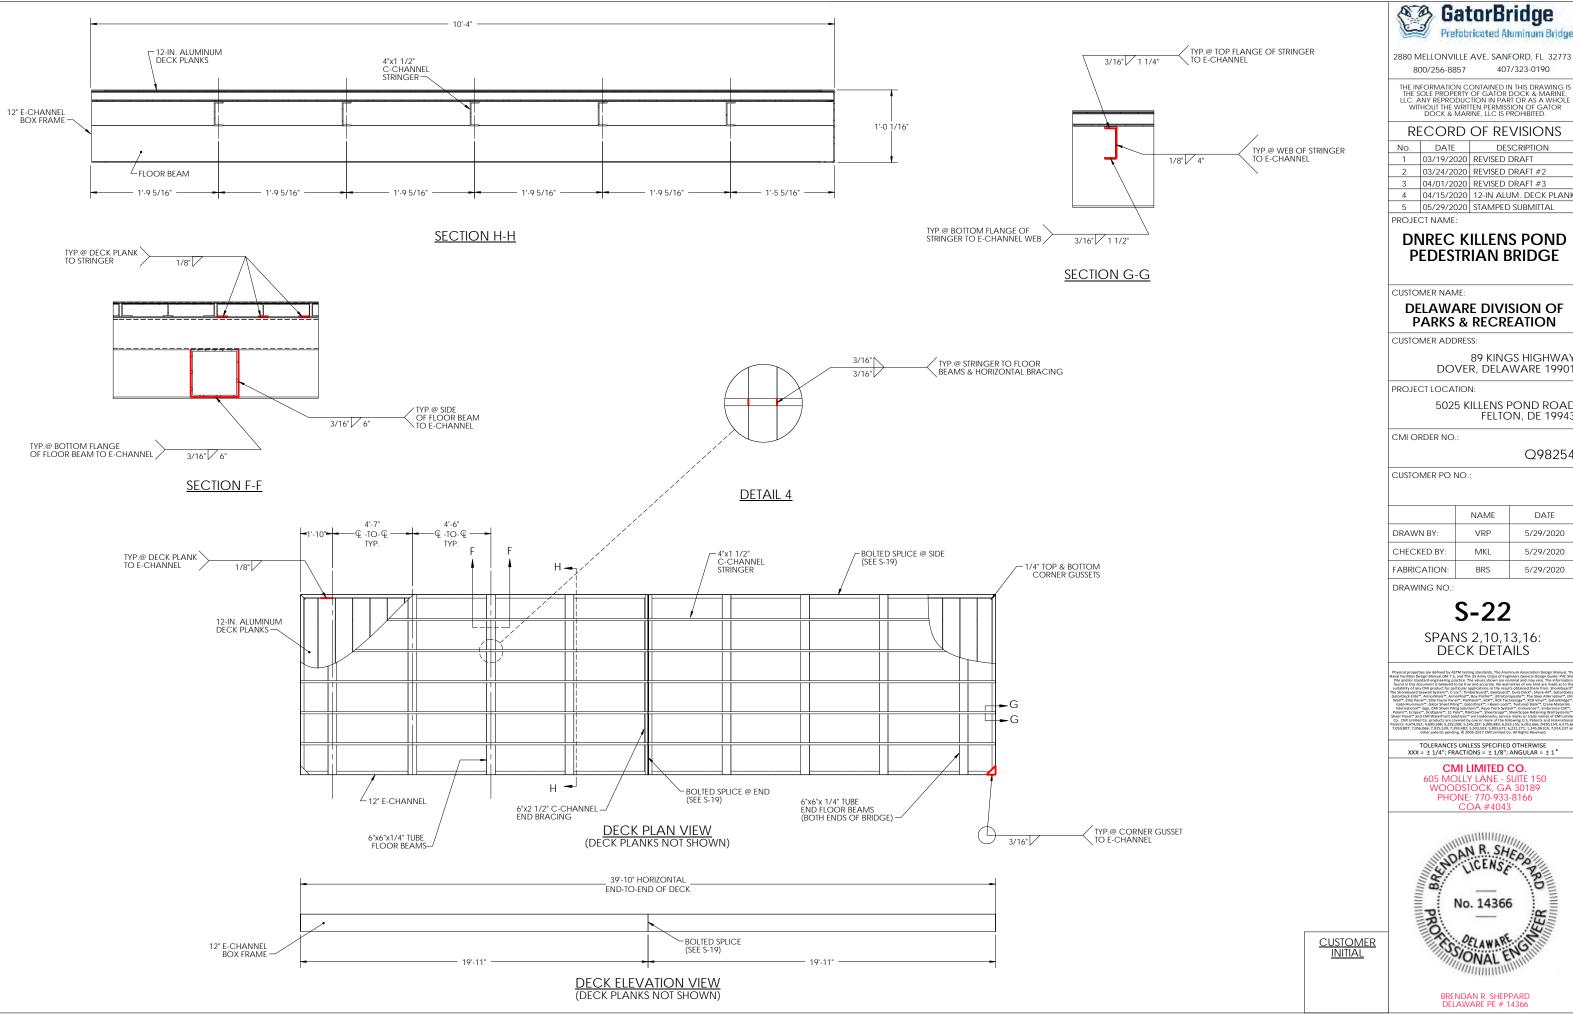5025 KILLENS POND ROAD FELTON, DE 19943


Q98254

	NAME	DATE
DRAWN BY:	VRP	5/29/2020
CHECKED BY:	MKL	5/29/2020
FABRICATION:	BRS	5/29/2020

605 MOLLY LANE - SUITE 150 WOODSTOCK, GA 30189 PHONE: 770-933-8166 COA #4043



BILL OF MATERIALS				
ITEM #	ТҮРЕ	DESCRIPTION	QTY/COMMENTS	WEIGHTS
SPAN 3,4,5,7,8, BRIDGE 10'x CA AND 9		10'x CASCADE BRIDGE	6 UNIQUE SPANS	~5,300 LBS TO ~5,600 LBS
1	BOX FRAME	12" E-CHANNEL	1	
2	TRUSS CHORDS	4"x4"x1/2" TUBE	4	
3	TRUSS END POSTS	4"x4"x1/2" TUBE	8	
4	TRUSS VERTICALS	4"x4"x1/4" TUBE	14	
5A	TRUSS END DIAGONALS	4"x4"x1/2" TUBE	4	
5B	TRUSS INTERIOR DIAGONALS	4"x4"x1/4" TUBE	12	
6	FLOOR STRINGERS	4"x1 1/2" C-CHANNEL	5	
7A	FLOOR BEAMS 4&5	6"x6"x1/4" TUBE	3	
7B	FLOOR BEAMS 2&3	6"x4"x1/4" TUBE	4	
8	HORIZONTAL BRACING	6"x2 1/2" C-CHANNEL	8	
9	FLOOR END BEAMS	6"x4"x1/4" TUBE	2	
10	DECKING	12-IN. ALUMINUM DECK PLANK	3/8" GAP	
11	BASE PLATE	9 1/2"x1'-4"x1/2" FLAT BAR	4	
12	BASE GUSSET	1/4" FLAT BAR GUSSET	12	
13	TOP CHORD END CAP	1/4" FLAT BAR END CAP	4	
14	COMBINATION RAIL	42" COMBINATION RAIL W/ 4" MAX SPACING	2	
15	RAIL BRACKET	3/8" PLATE	36	
16	DECK CORNER GUSSETS	1/4" DECK CORNER GUSSETS	8	
BP1	BEARING PAD	9 1/2"x1'-6"x1" UHMW PAD	4 x 6 = 24	~5 LBS (EACH)

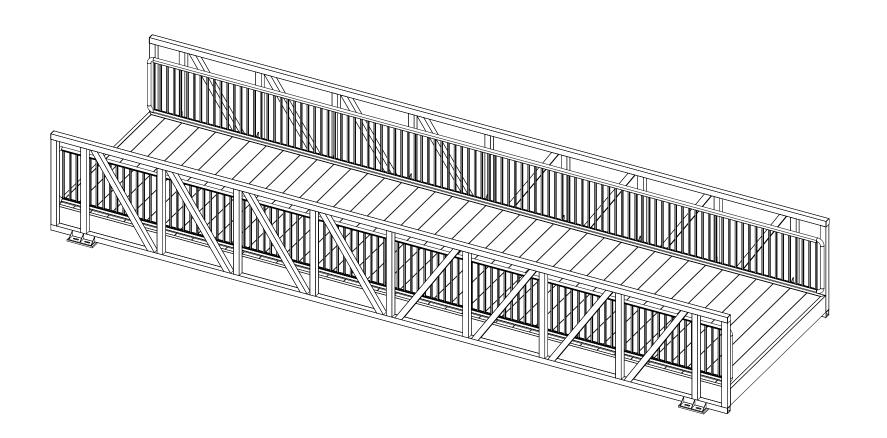



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5	05/29/2020	STAMPED SUBMITTAL

PROJECT NAME:

DNREC KILLENS POND PEDESTRIAN BRIDGE

CUSTOMER NAME:

DELAWARE DIVISION OF PARKS & RECREATION

CUSTOMER ADDRESS:

89 KINGS HIGHWAY DOVER, DELAWARE 19901

PROJECT LOCATION:

5025 KILLENS POND ROAD FELTON, DE 19943

CMI ORDER NO.:

Q98254

CUSTOMER PO NO.:

	NAME	DATE
DRAWN BY:	KLC	05/22/2020
CHECKED BY:	MKL	05/29/2020
FABRICATION:	BRS	05/29/2020

DRAWING NO.:

S-23

SPANS 3,4,5,7,8,9: MATERIAL LIST


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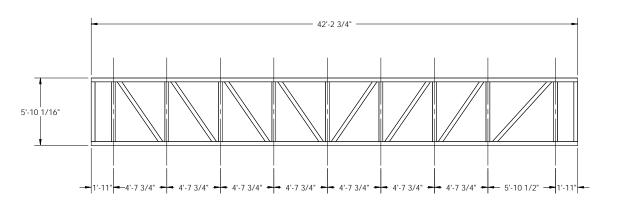
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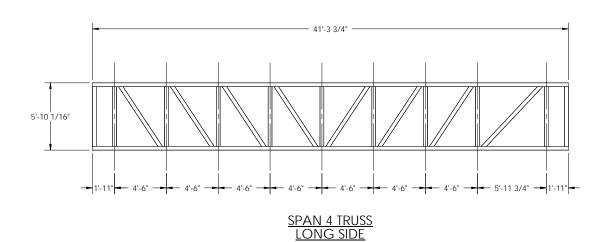
NO.	DAIL	DESCRIPTION
1	03/19/2020	REVISED DRAFT
2	03/24/2020	REVISED DRAFT #2
3	04/01/2020	REVISED DRAFT #3
4	04/15/2020	12-IN ALUM. DECK PLANK


	NAME	DATE
DRAWN BY:	KLC	05/22/2020
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FABRICATION:	BRS	05/29/2020







SPAN 3 TRUSS LONG SIDE

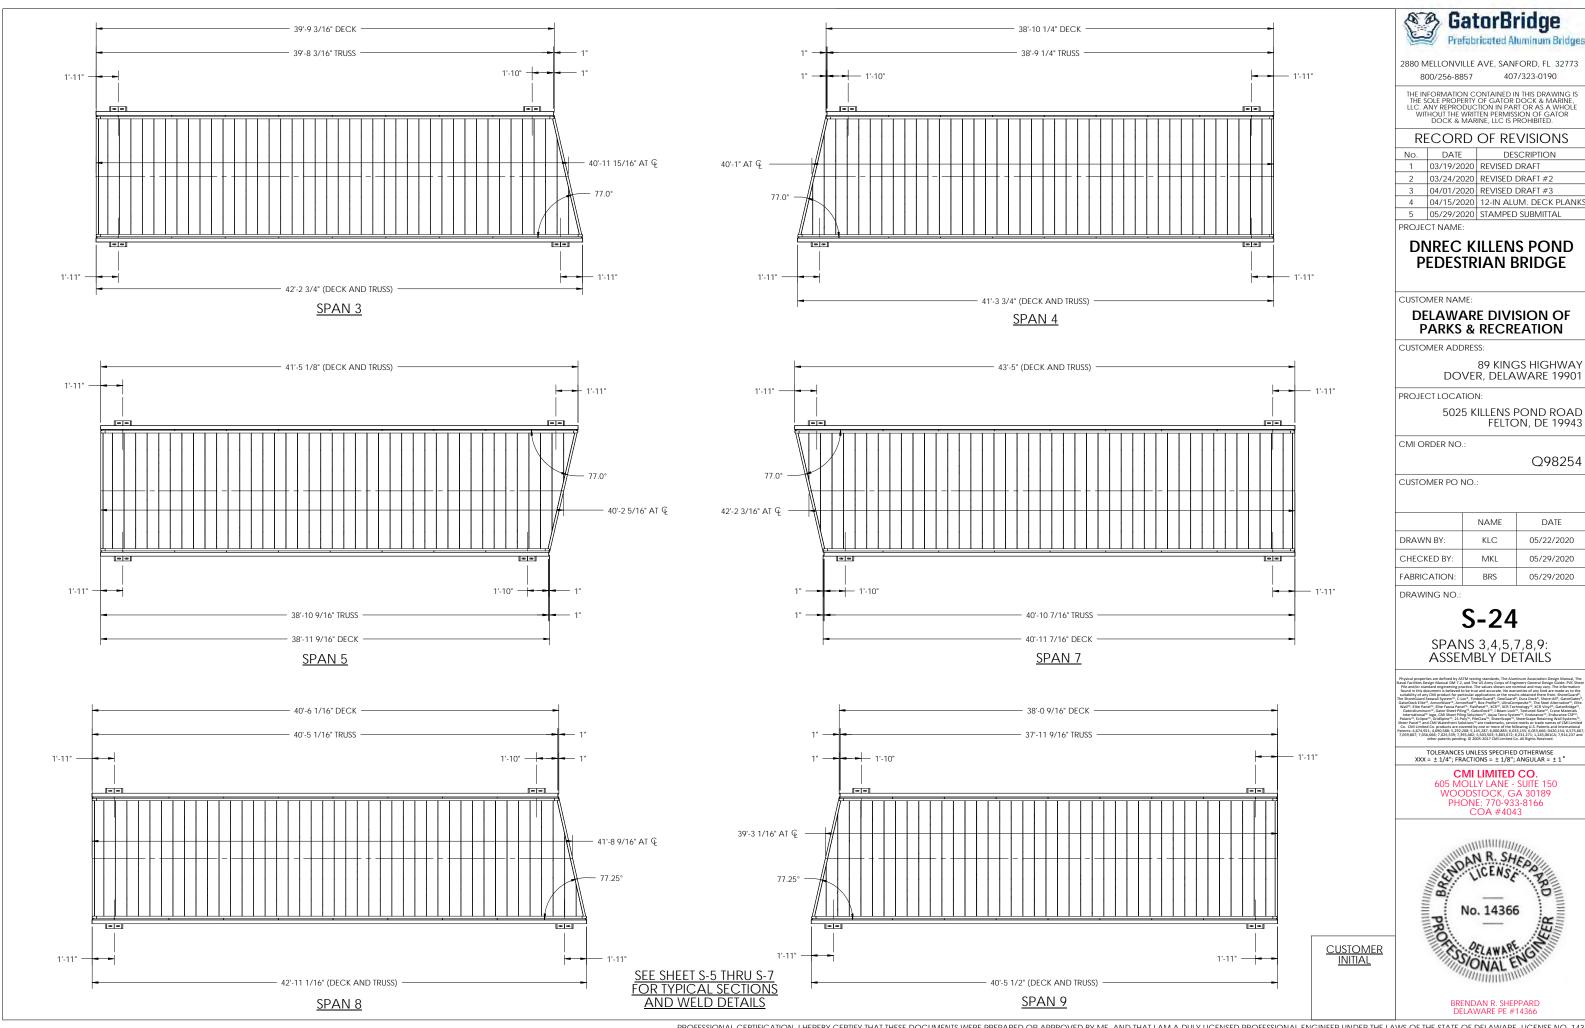


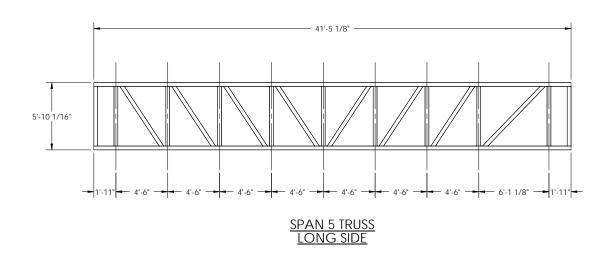

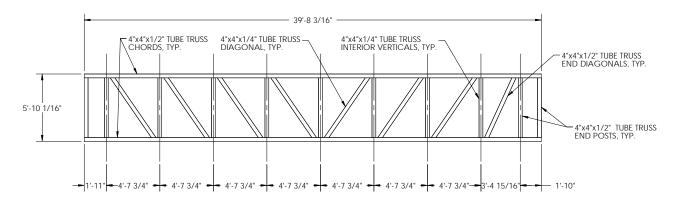

SPAN 3 TRUSS SHORT SIDE

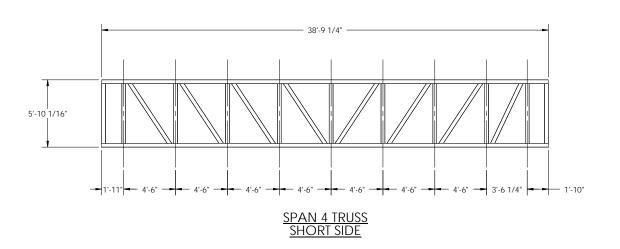

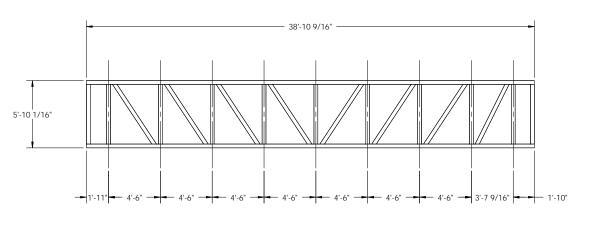

SPAN 5 TRUSS SHORT SIDE

SEE SHEET S-5 THRU S-7 FOR TYPICAL SECTIONS AND WELD DETAILS

CUSTOMER INITIAL



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PROJECT NAME:

DNREC KILLENS POND PEDESTRIAN BRIDGE

CUSTOMER NAME:

DELAWARE DIVISION OF PARKS & RECREATION

CUSTOMER ADDRESS:

89 KINGS HIGHWAY DOVER, DELAWARE 19901

PROJECT LOCATION:

5025 KILLENS POND ROAD FELTON, DE 19943

CMI ORDER NO.:

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FABRICATION:	BRS	05/29/2020

DRAWING NO.:

S-25


SPANS 3,4,5,7,8,9: TRUSS DETAILS (1/2)


TOLERANCES UNLESS SPECIFIED OTHERWISE XXX = ± 1/4"; FRACTIONS = ± 1/8"; ANGULAR = ± 1°

CMI LIMITED CO.


605 MOLLY LANE - SUITE 150 WOODSTOCK, GA 30189 PHONE: 770-933-8166 COA #4043




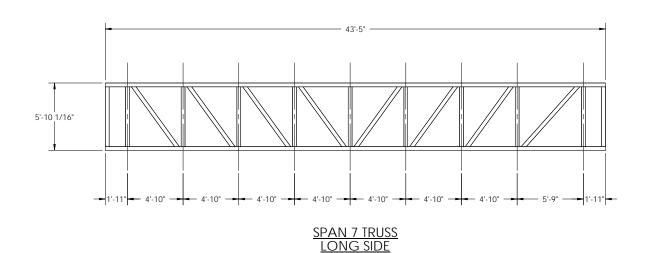


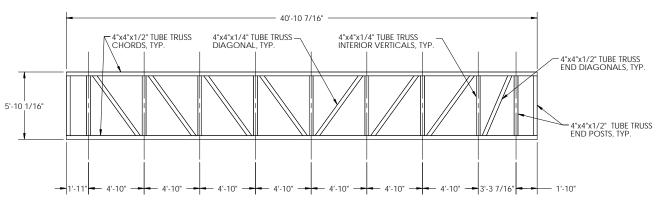


SPAN 7 TRUSS SHORT SIDE

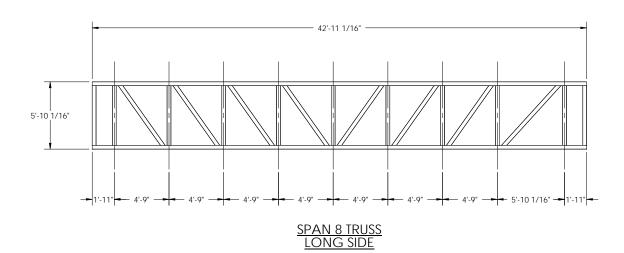

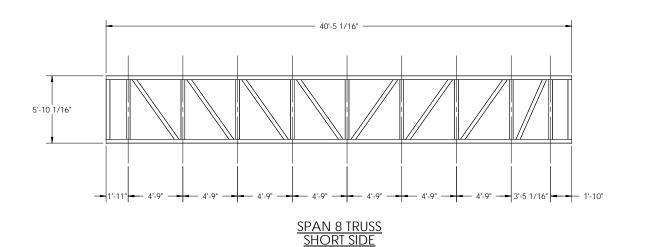

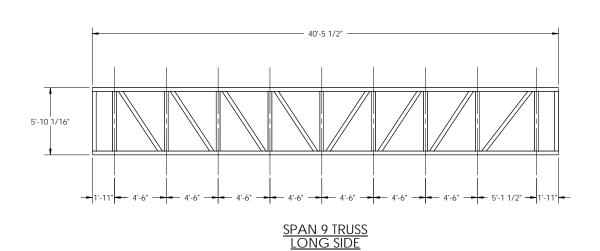

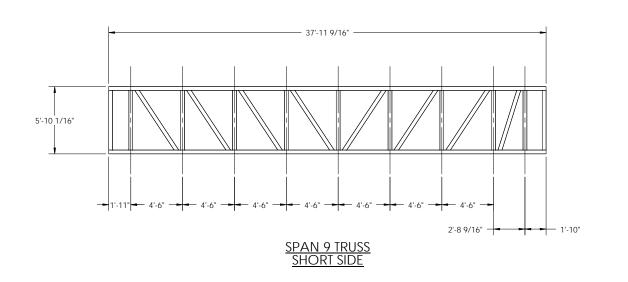

SEE SHEET S-5 THRU S-7 FOR TYPICAL SECTIONS AND WELD DETAILS

CUSTOMER INITIAL



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RECORD OF REVISIONS

No.	DATE	DESCRIPTION
1	03/19/2020	REVISED DRAFT
2	03/24/2020	REVISED DRAFT #2
3	04/01/2020	REVISED DRAFT #3
4	04/15/2020	12-IN ALUM. DECK PLAN
5	05/29/2020	STAMPED SUBMITTAL

PROJECT NAME:

DNREC KILLENS POND PEDESTRIAN BRIDGE

CUSTOMER NAME:

DELAWARE DIVISION OF PARKS & RECREATION

CUSTOMER ADDRESS:

89 KINGS HIGHWAY DOVER, DELAWARE 19901

PROJECT LOCATION:

5025 KILLENS POND ROAD FELTON, DE 19943

CMI ORDER NO.:

Q98254

CUSTOMER PO NO .:

	NAME	DATE
DRAWN BY:	KLC	05/22/2020
CHECKED BY:	MKL	05/29/2020
FABRICATION:	BRS	05/29/2020

DRAWING NO.:

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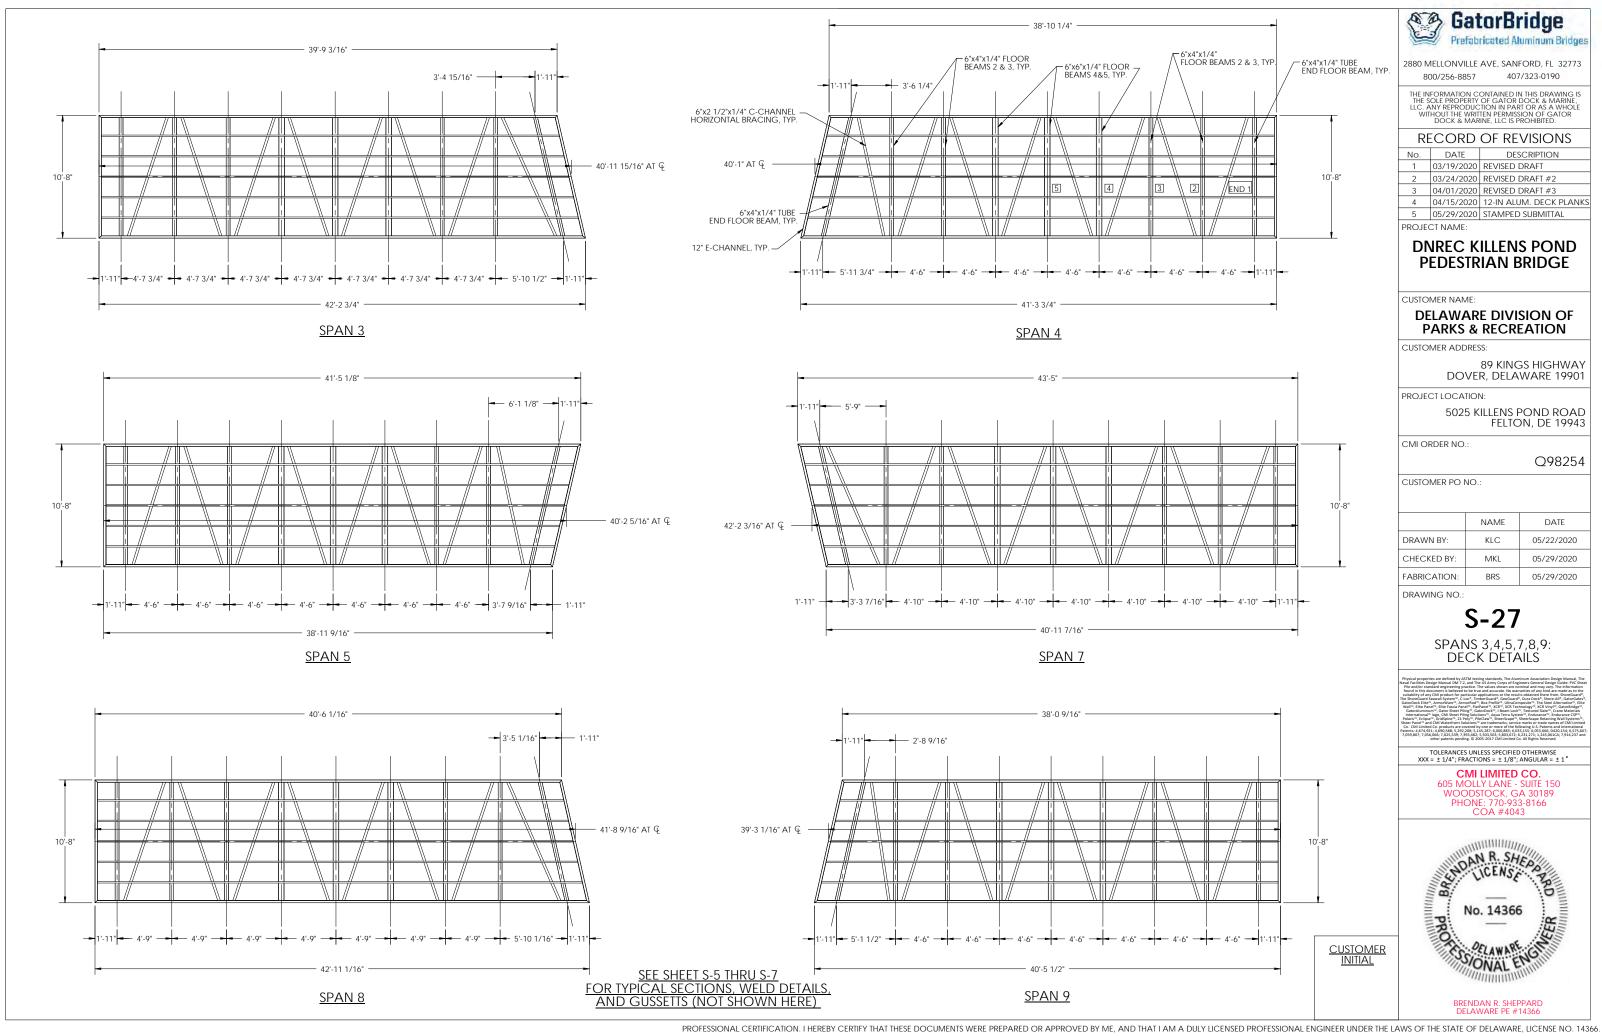
SPANS 3,4,5,7,8,9: TRUSS DETAILS (2/2)


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CMI LIMITED CO.

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DNREC KILLENS POND PEDESTRIAN BRIDGE

CUSTOMER NAME:

DELAWARE DIVISION OF PARKS & RECREATION

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89 KINGS HIGHWAY DOVER, DELAWARE 19901
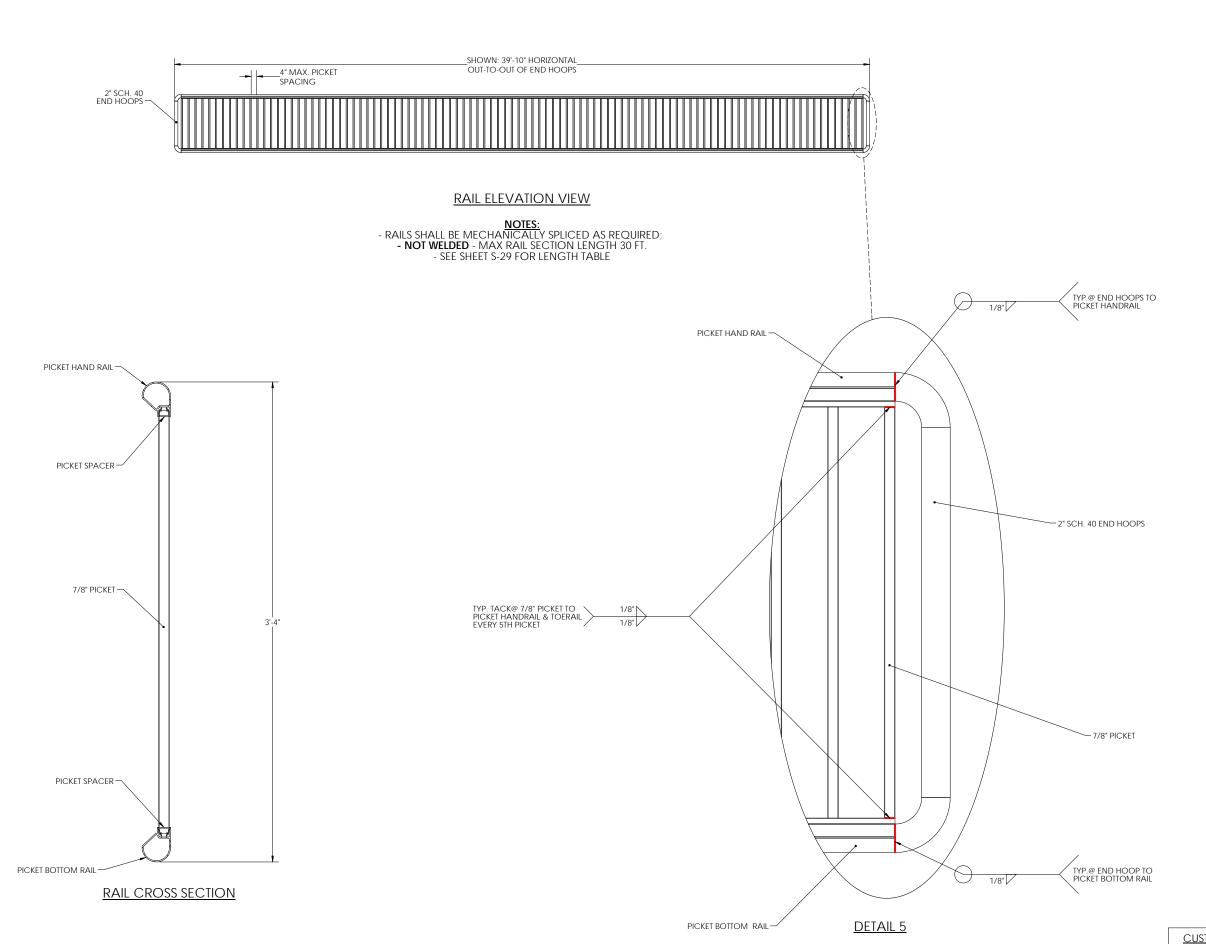
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	FABRICATION:	BRS	05/29/2020

DRAWING NO.:

S-28

DETAILS

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CMI LIMITED CO.

CON LINITED CO. 605 MOLLY LANE - SUITE 150 WOODSTOCK, GA 30189 PHONE: 770-933-8166 COA #4043



* US PATENTS NO. 6,811,146 & 7,168,689 THIS PRODUCT IS A PROPRIETARY DESIGN AND MAY ONLY BE MANUFACTURED UNDER LICENSE FROM PEDRO P. GIRALT, P.E.

SPAN	RAIL LENGTH: LEFT SIDE	RAIL LENGTH: RIGHT SIDE
1	32'-10 1/8"	32'-10 1/8"
2	FISHING RAIL	39'-10"
3	39'-9 3/16"	42'-2 3/4"
4	38'-10 1/4"	41'-3 3/4"
5	41'-5 1/8"	38'-11 9/16"
6	86'-3 9/16"	81'-4 7/16"
7	43'-5"	40'-11 7/16"
8	40'-6 1/16"	42'-11 1/16"
9	38'-0 9/16"	40'-5 1/2"
10	FISHING RAIL	39'-10"
11	39'-10"	39'-10"
12	39'-10"	39'-10"
13	FISHING RAIL	39'-10"
14	39'-10"	39'-10"
15	39'-10"	39'-10"
16	FISHING RAIL	39'-10"
17	39'-10"	39'-10"
18	39'-10"	39'-10"
19	39'-10"	39'-10"
20	49'-8 9/16"	49'-8 9/16"



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5	05/29/2020	STAMPED SUBMITTAL

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CUSTOMER NAME:

DELAWARE DIVISION OF PARKS & RECREATION

CUSTOMER ADDRESS:

89 KINGS HIGHWAY DOVER, DELAWARE 19901

PROJECT LOCATION:

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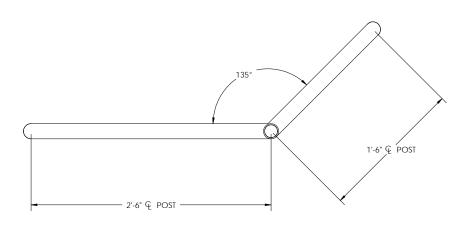
S-29

PICKET RAIL: LENGTH CHART

TOLERANCES UNLESS SPECIFIED OTHERWISE XXX = \pm 1/4"; FRACTIONS = \pm 1/8"; ANGULAR = \pm 1°


CMI LIMITED CO. 605 MOLLY LANE - SUITE 150 WOODSTOCK, GA 30189 PHONE: 770-933-8166 COA #4043






APPROACH RAIL TYPE 1 PLAN VIEW


QTY. = 2

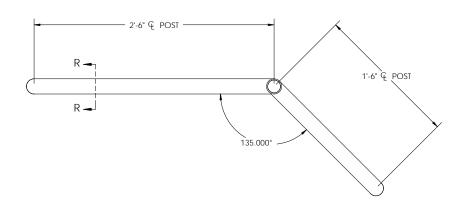

APPROACH RAIL TYPE 2 PLAN VIEW

QTY. = 2

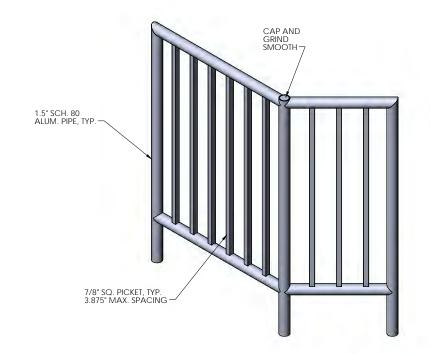

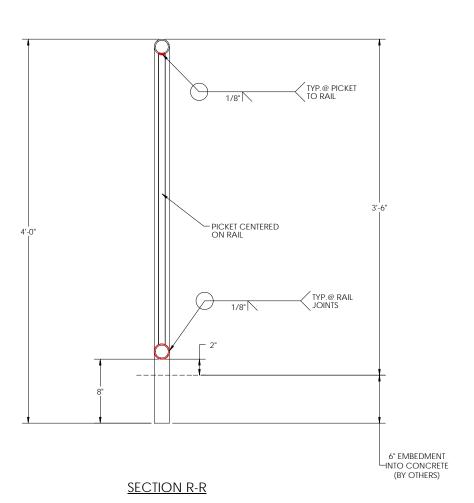



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	FABRICATION:	BRS	05/29/2020

DRAWING NO.:

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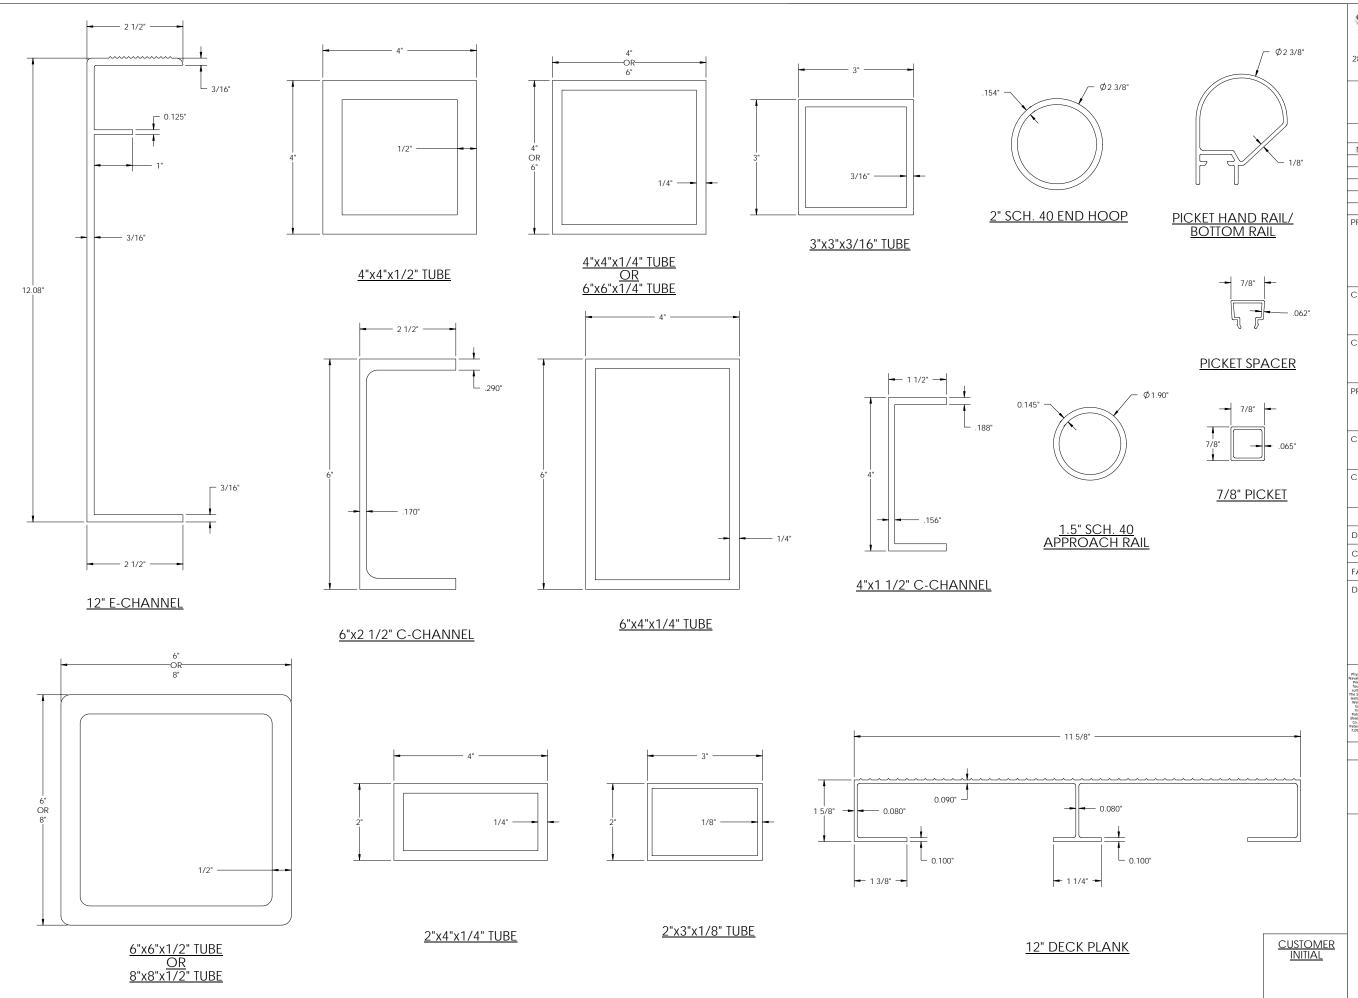
APPROACH RAIL DETAILS

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BRENDAN R. SHEPPARD DELAWARE PE #14366





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	FABRICATION:	BRS	05/29/2020

DRAWING NO.:

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STRUCTURAL COMPONENT DETAILS

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